
# COASTSIDE FIRE PROTECTION DISTRICT FIRE STATION #41

OBISPO ROAD, EL GRANADA, CA 94018



**Location Map** 

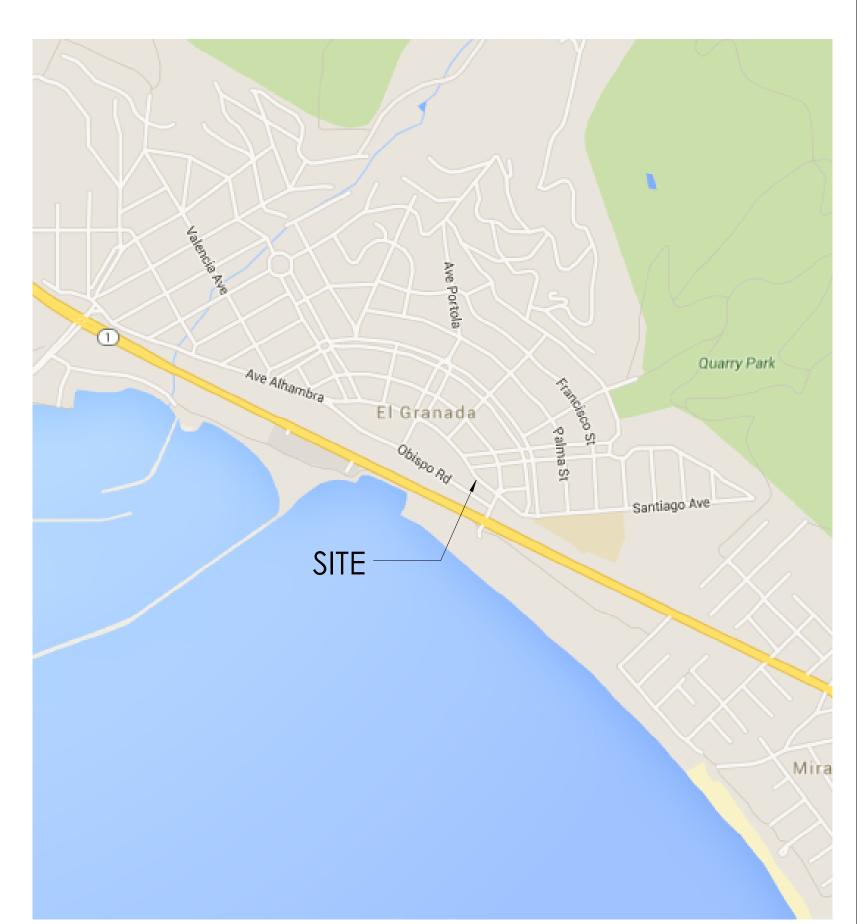

**VICINITY MAP** 



OBISPO ROAD EL GRANADA, CA 94018 047-261-030 COASTSIDE FIRE PROTECTION DISTRICT **OWNER:** HALF MOON BAY, CA 94019 SAN MATEO COUNTY **GOVERNING AGENCY:** PLANNING AND BUILDING DEPARTMENT 2013 CBC **GOVERNING CODES:** CONSTRUCTION OF A NEW 12,340 **SCOPE OF WORK:** SQUARE FOOT FIRE STATION EG, DR, CD C-1/S-3/DR <u>ZONING:</u> B, R-2, S-2 OCCUPANCY GROUP: V-B FULLY SPRINKLED ALLOWABLE BLDG AREA: 9,000 S.F. 7,000 S.F. S-2 13,500 S.F. ACTUAL BLDG AREA: TOTAL BUILDING AREA 12,425 S.F. **ACTUAL AREA:** B ACTUAL: 966 S.F. R-2 ACTUAL: 2,953 S.F. S-2 ACTUAL: 6,253 S.F. 117,093 S.F. SITE AREA: (2.7 ACRES) 11,709 S.F. ALLOWABLE IMPERIOUS AREA (10%): (.27 ACRES) 36,000 S.F. **ACTUAL IMPERIOUS AREA (30%):** (.8 ACRES) **NUMBER OF STORIES:** 30' - 0'' MAX BUILDING HEIGHT: Parking Required: Public: No Requirement Parking Provided: Accessible Parking Spaces: Public Parking: Standard Parking Spaces: Standard Parking Spaces: Fire Personnel Total Parking:

**Project Data** 

**Legal Description** 

PARCEL: 047-261-030, CERTIFICATE OF COMPLIANCE - 2015-087529, RECORDED IN SAN MATEO COUNTY 08/19/2016

OF A PORTION OF THE SAN MATEO COUNTY HARBOR DISTRICT PROPERTY AS RECORDED IN BOOK 1472 OR PAGE 142 (56155-H) BEING A PART OF THE PALOMARES RANCHO AND SITUATED IN EL GRANADA SAN MATEO COUNTY, CALIFORNIA.

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TITLE SHEET

PLANNING

Project Number:

Checker

Approved By:

Checked By:

Drawn By:

Sheet Title:

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Sheet Number:





Description: Date:
PLANNING 08/16/1

SUBMITTAL

OBISPO ROAD EL GRANADA, CA 94018 2. ALL APPLICABLE WORK AND MATERIALS SHALL BE DONE IN ACCORDANCE WITH THE COUNTY OF SAN MATEO STANDARD TECHNICAL SPECIFICATIONS AND DETAILS, PREPARED IN THE OFFICE OF ENGINEERING AND CONSTRUCTION, INCLUDING MODIFICATIONS CONTAINED HEREIN.

3. THE CONTRACTOR SHALL RESTORE ALL DAMAGED, REMOVED OR OTHERWISE DISTURBED WALLS, FENCES, SERVICES, UTILITIES, IMPROVEMENTS OR FEATURES OF WHATEVER NATURE, DUE TO CONTRACTOR'S WORK.

4. THE CONTRACTOR SHALL COORDINATE HIS WORK WITH THE INSTALLATION OF FACILITIES BY PG&E, AT&T, AND COMCAST. VALVE BOXES, MANHOLES, AND STRUCTURES TO BE SET TO GRADE IN CONCRETE AFTER PAVING.

5. ALL STREET MONUMENTS AND OTHER PERMANENT MONUMENTS DISTURBED DURING THE PROCESS OF CONSTRUCTION SHALL BE REPLACED BEFORE ACCEPTANCE OF THE IMPROVEMENT BY THE COUNTY ENGINEER.

6. THE CONTRACTOR SHALL GIVE THE COUNTY ENGINEER AND OWNER TWO (2) WORKING DAYS ADVANCE NOTICE FOR INSPECTION SERVICES.

7. NO TREES 12" IN DIAMETER OR LARGER MEASURED BETWEEN 6" AND 36" ABOVE GRADE, SHALL BE REMOVED WITHOUT THE WRITTEN CONSENT OF THE COUNTY ENGINEER. TREE REMOVALS, IF NECESSARY, SHALL CONFORM TO THE HERITAGE TREE ORDINANCE, ORDINANCE NO. 1536.

8. FOR LANE CLOSURES, THE CONTRACTOR SHALL PREPARE A TRAFFIC CONTROL PLAN AND OBTAIN APPROVAL OF THE COUNTY ENGINEER BEFORE COMMENCING WORK. THE CONTRACTOR SHALL ALSO PROVIDE FLAGMEN, CONES OR BARRICADES, AS NECESSARY TO CONTROL TRAFFIC AND PREVENT HAZARDOUS CONDITIONS PER THE CALIFORNIA STANDARD PLANS, SPECIFICATIONS, AND MANUAL ON TRAFFIC CONTROL DEVICES, LATEST

9. THE CONTRACTOR SHALL LEAVE A 24-HOUR EMERGENCY TELEPHONE NUMBER WITH POLICE, FIRE AND PUBLIC WORKS DEPARTMENTS, AND KEEP THEM INFORMED DAILY OF DETOURS.

10. PEDESTRIAN, PUBLIC ACCESSES, WHEELCHAIR ACCESSES SHALL BE MAINTAINED DURING CONSTRUCTION TO THE SATISFACTION OF THE COUNTY

11. NO TRENCHES OR HOLES SHALL BE LEFT OPEN OVERNIGHT; USE STEEL PLATING OR HOT-MIX ASPHALT AS REQUIRED TO PROTECT OPEN TRENCHES OVERNIGHT

12. THE CONTRACTOR SHALL PROVIDE DUST CONTROL AND VACUUM STREETS AS OFTEN AS NECESSARY DURING CONSTRUCTION AS REQUIRED BY THE

13. ALL REVISIONS TO THIS PLAN MUST BE REVIEWED AND APPROVED BY THE COUNTY ENGINEER PRIOR TO CONSTRUCTION AND SHALL BE ACCURATELY SHOWN ON REVISED PLANS STAMPED AND SIGNED BY COUNTY ENGINEER PRIOR TO THE INSTALLATION OF THE IMPROVEMENTS.

14. ALL CONSTRUCTION STAKING FOR CURB, GUTTER, SIDEWALK, SANITARY SEWERS, STORM DRAINS, WATER LINES, FIRE HYDRANTS, ELECTROLIERS, ETC., SHALL BE DONE BY A REGISTERED CIVIL ENGINEER OR LICENSED LAND

15. WORK SHALL BE PERFORMED IN ACCORDANCE WITH THE PROJECT SPECIFICATIONS AND THESE NOTES.

16. STANDARD CONSTRUCTION ACTIVITIES SHALL BE LIMITED TO BETWEEN 7:00 A.M. AND 5:00 P.M., MONDAY THROUGH FRIDAY. NO CONSTRUCTION ACTIVITY SHALL TAKE PLACE ON SATURDAYS, SUNDAYS AND LEGAL HOLIDAYS UNLESS APPROVED, IN WRITING, BY THE OWNER AND COUNTY.

17. PRIOR TO FINAL PREPARATION OF THE SUBGRADE AND PLACEMENT OF BASE MATERIALS FOR PAVED AREAS, UNDERGROUND UTILITY MAINS SHALL BE INSTALLED AND SERVICE CONNECTIONS STUBBED OUT. STUB-OUTS SHALL BE INSTALLED IN A MANNER WHICH WILL NOT DISTURB THE PAVEMENT, CURB AND GUTTER AND WALKS WHEN SERVICE CONNECTIONS ARE MADE.

18. EXCAVATIONS SHALL BE ADEQUATELY SHORED, BRACED AND SHEATHED SO THAT THE EARTH WILL NOT SLIDE OR SETTLE AND SO THAT EXISTING IMPROVEMENTS WILL BE FULLY PROTECTED FROM DAMAGE. DAMAGE RESULTING FROM A LACK OF ADEQUATE SHORING, BRACING AND SHEATHING, SHALL BE THE RESPONSIBILITY OF THE CONTRACTOR AND HE SHALL COMPLETE NECESSARY REPAIRS OR RECONSTRUCTION AT HIS OWN EXPENSE. WHERE THE EXCAVATION FOR A CONDUIT TRENCH, AND/OR STRUCTURE IS FIVE (5) FEET OR MORE IN DEPTH, THE CONTRACTOR SHALL PROVIDE SHEATHING, SHORING AND BRACING IN CONFORMANCE WITH THE APPLICABLE CONSTRUCTION SAFETY ORDERS OF THE DIVISION OF INDUSTRIAL SAFETY OF THE STATE OF CALIFORNIA. THE CONTRACTOR SHALL COMPLY WITH OSHA

19. DURING CONSTRUCTION, THE CONSTRUCTION AREA AND COUNTY STREETS SHALL BE CLEANED AS OFTEN AS REQUIRED TO REMOVE ACCUMULATION OF MUD AND DEBRIS RESULTING FROM CONSTRUCTION. IF IMPORT OR EXPORT OF DIRT IS NECESSARY, THE CONTRACTOR SHALL DATAIN AN APPROVAL FOR THE HAULING ROUTE FROM THE COUNTY ENGINEERING DIVISION. THE HAULING ROUTES SHALL BE STRICTLY ADHERED TO BY THE CONTRACTOR AND SUBCONTRACTORS. DIRT HAULING PERMIT REQUIRED.

20. SHOULD IT APPEAR THAT THE WORK OUTLINED ON THESE PLANS IS NOT SUFFICIENTLY DETAILED OR SPECIFIED IN THE CONSTRUCTION DOCUMENTS, THE CONTRACTOR SHALL NOTIFY THE ARCHITECT BEFORE PROCEEDING WITH THE WORK IN QUESTION AND REQUEST CLARIFICATION.

21. WHEN SPECIFICATIONS OR STANDARDS FROM DIFFERENT AUTHORITIES DIFFER FOR THE SAME SUBJECT MATTER, NOTIFY OWNER AND REQUEST

22. UPON SATISFACTORY COMPLETION OF THE WORK, THE WORK SITE SHALL BE CLEANED UP AND LEFT WITH A SMOOTH AND NEATLY GRADED SURFACE FREE OF CONSTRUCTION WASTE AND RUBBISH OF ANY NATURE BY THE CONTRACTOR TO THE SATISFACTION OF THE ENGINEER AND OWNER.

23. ARTICLE 87 OF THE UFC SHALL BE FOLLOWED FOR AREAS UNDER CONSTRUCTION. CONTACT THE COUNTY FIRE DEPARTMENT FOR SPECIFIC REQUIREMENTS FOR BUILDINGS UNDER CONSTRUCTION.

24. THE CONTRACTOR SHALL BE AWARE THAT DEWATERING ACTIVITIES SHALL COMPLY WITH THE CONDITIONS OF THE BAY AREA REGIONAL WATER QUALITY CONTROL BOARD GENERAL PERMIT FOR CONSTRUCTION SITES.

25. THE CONTRACTOR SHALL ABIDE BY THE RULES AND REGULATIONS OF THE STATE OF CALIFORNIA CONSTRUCTION SAFETY ORDERS PERTAINING TO EXCAVATIONS AND TRENCHES.

26. THE CONTRACTOR SHALL ADJUST TO FINAL GRADE EXISTING AND/OR NEW UTILITY BOX, MANHOLES, CURB INLETS, CATCH BASINS, VALVES, MONUMENT COVERS, AND OTHER CASTINGS WITHIN THE WORK AREA TO FINAL GRADE IN PAVEMENT AND LANDSCAPE AREAS, UNLESS NOTED OTHERWISE.

GRADE IN PAVEMENT AND LANDSCAPE AREAS, UNLESS NOTED OTHERWISE.

27. THE CONTRACTOR SHALL MEET AND FOLLOW NPDES REQUIREMENTS IN EFFECT AT THE TIME OF CONSTRUCTION.

28. IF ARCHAEOLOGICAL MATERIALS ARE UNCOVERED DURING DEMOLITION WORK, WORK WITHIN 100 FEET OF THESE MATERIALS SHALL BE STOPPED UNTIL A PROFESSIONAL ARCHAEOLOGIST WHO IS CERTIFIED BY THE SOCIETY OF CALIFORNIA ARCHAEOLOGY (SCA) AND/OR THE SOCIETY OF PROFESSIONAL ARCHAEOLOGY (SOPA) HAS HAD AN OPPORTUNITY TO EVALUATE THE SIGNIFICANCE OF THE FIND AND SUGGEST APPROPRIATE MITIGATION MEASURES, IF THEY ARE DEEMED NECESSARY.

## II. LAYOUT NOTES

1. CURB RETURN RADII AND CURB DATA ARE TO FACE OF CURB UNLESS OTHERWISE NOTED.

2. CURB INLETS ARE REFERENCED TO CENTERLINE OF STRUCTURE AT TOP OF CURB.

3. DRAINAGE AND SANITARY SEWER STRUCTURES ARE REFERENCED TO CENTER OF STRUCTURE UNLESS OTHERWISE NOTED.

#### III. EXISTING CONDITIONS

1. EXISTING TOPOGRAPHIC INFORMATION SHOWN ON THESE PLANS IS BASED ON TOPOGRAPHIC SURVEY DATA COLLECTED BETWEEN TBD THROUGH TBD BY BKF ENGINEERS AND AERIAL TOPO DATED MARCH 5, 2015. GRADES ENCOUNTERED ON—SITE MAY VARY FROM THOSE SHOWN. CONTRACTOR SHALL REVIEW THE PLANS AND SPECIFICATIONS AND CONDUCT FIELD

INVESTIGATIONS TO VERIFY EXISTING CONDITIONS AT THE PROJECT SITE. 2. INFORMATION REGARDING EXISTING SUBSURFACE IMPROVEMENTS AND UTILITIES SHOWN ON THESE PLANS WAS TAKEN FROM SURVEY DATA, RECORD DATA KNOWN TO THE DESIGN ENGINEER AND IS NOT MEANT TO BE A FULL CATALOG OF EXISTING CONDITIONS. THE TYPES, LOCATIONS, SIZES AND/OR DEPTHS OF EXISTING UNDERGROUND UTILITIES AS SHOWN ON THIS TOPOGRAPHIC SURVEY ARE APPROXIMATE AND WERE OBTAINED FROM SOURCES OF VARYING RELIABILITY. ONLY ACTUAL EXCAVATION WILL REVEAL THE TYPES, EXTENT, SIZES, LOCATIONS AND DEPTHS OF SUCH UNDERGROUND UTILITIES. A REASONABLE EFFORT HAS BEEN MADE TO LOCATE AND DELINEATE ALL KNOWN UNDERGROUND UTILITIES. HOWEVER, THE ENGINEER CAN ASSUME NO RESPONSIBILITY FOR THE COMPLETENESS OR ACCURACY OF ITS DELINEATION OF SUCH UNDERGROUND UTILITIES WHICH MAY BE ENCOUNTERED, BUT WHICH ARE NOT SHOWN ON THIS SURVEY. CONTRACTOR SHALL CONDUCT FIELD INVESTIGATIONS AS REQUIRED TO VERIFY THE LOCATION AND ELEVATION OF EXISTING SUBSURFACE IMPROVEMENTS AND UTILITIES (WHETHER SHOWN ON THESE PLANS OR NOT) PRIOR TO THE COMMENCEMENT OF WORK. CONTRACTOR SHALL NOTIFY THE CIVIL DESIGN ENGINEER IMMEDIATELY UPON DISCOVERY OF ANY DISCREPANCIES BETWEEN EXISTING CONDITIONS IN THE FIELD AND INFORMATION SHOWN ON THESE

3. ELEVATIONS AND LOCATIONS OF EXISTING UTILITIES SHALL BE VERIFIED BY THE CONTRACTOR PRIOR TO START OF CONSTRUCTION AFFECTING SAID LINES.

#### IV. UTILITIES

1. BEFORE DISCONNECTING UTILITY SERVICE TO ANY ESTABLISHMENT, CONTRACTOR SHALL GIVE ADVANCE NOTICE TO ESTABLISHMENT BEFORE THEIR UTILITY IS SHUT DOWN, MAKE ARRANGEMENTS WITH THOSE ESTABLISHMENTS FOR A SCHEDULED SHUT DOWN AND COORDINATE DATE OF SHUT DOWN, DURATION, INCONVENIENCE, DELAYS, ETC. WITH A REPRESENTATIVE OF THE COUNTY AND/OR RESPECTIVE UTILITY AGENCY.

#### V. GRADING

1. GRADING WORK SHALL BE PERFORMED IN ACCORDANCE WITH THE TECHNICAL SPECIFICATIONS AND THE REQUIREMENTS AND RECOMMENDATIONS CONTAINED IN "XX" PREPARED BY XX, PROJECT NUMBER XX, DATED XX.

2. CONTRACTOR SHALL EXERCISE EXTREME CARE TO CONFORM TO THE LINES, GRADES, SECTIONS, AND DIMENSIONS AS SET FORTH ON THESE PLANS. GRADED AREAS SHALL CONFORM TO THE VERTICAL ELEVATIONS SHOWN WITHIN TOLERANCE OF ONE—TENTH OF A FOOT IN LANDSCAPE AREAS AND TWO HUNDRETHS OF A FOOT IN HARDSCAPE AREAS. MINIMUM THICKNESSES SHALL BE MAINTAINED WHERE NOTED. MINIMUM AND MAXIMUM SLOPES SHALL BE NOT BE EXCEEDED UNDER ANY CIRCUMSTANCE. WHERE GRADED AREAS DO NOT CONFORM TO THESE TOLERANCES, THE CONTRACTOR SHALL BE REQUIRED TO DO CORRECTIVE GRADING, AT NO EXTRA COST TO THE OWNER.

3. THE GEOTECHNICAL ENGINEER SHALL BE NOTIFIED AT LEAST TWO (2) WORKING DAYS PRIOR TO COMMENCEMENT OF GRADING OPERATIONS.

4. THE GEOTECHNICAL ENGINEER WILL BE PRESENT AT THE SITE DURING FOOTING EXCAVATION AND OTHER GRADING OPERATIONS, AND SHALL PERFORM TESTING DEEMED NECESSARY. THE GEOTECHNICAL ENGINEER SHALL OBSERVE GRADING OPERATIONS AND IDENTIFY THOSE CONDITIONS WITH RECOMMENDED CORRECTIVE MEASURES TO THE CONTRACTOR AND THE CONSTRUCTION MANAGER.

5. UPON COMPLETION OF FOOTING EXCAVATION AND OTHER GRADING OPERATIONS, THE GEOTECHNICAL ENGINEER WILL PROVIDE A WRITTEN REPORT DOCUMENTING THE RESULTS OF THE GEOTECHNICAL ENGINEER'S SITE OBSERVATION AND TESTING ACTIVITIES PERFORMED DURING SITE GRADING

6. EARTHWORK QUANTITIES SHOWN ON THESE PLANS ARE FOR PERMIT PURPOSES. THE CONTRACTOR SHALL MAKE HIS OWN DETERMINATION OF EARTHWORK QUANTITIES FOR BUILDING PURPOSES PRIOR TO BIDDING. FINAL GRADING QUANTITIES ARE DEPENDENT ON FIELD CONDITIONS, CONSTRUCTION TECHNIQUES AND SEQUENCES, FINAL COMPACTION OBTAINED, TRENCHING AND BACKFILL METHODS AND NUMEROUS OTHER FACTORS OUT OF THE CONTROL THE DESIGNER. ANY IMPORT OR EXPORT REQUIRED SHALL BE REFLECTED IN THE BID. NO ADDITIONAL COMPENSATION WILL BE MADE FOR IMPORT OR EXPORT REQUIRED UNLESS NECESSITATED BY UNFORESEEN FIELD CONDITIONS (E.G. UNSUITABLE EXISTING SOIL NOT DETECTED IN THE GEOTECHNICAL INVESTIGATION REPORT).

## VI. STORM DRAIN NOTES

1. THE ON-SITE PRIVATE STORM DRAIN SYSTEM SHALL BE INSTALLED BY THE CONTRACTOR IN ACCORDANCE WITH THESE PLANS AND COUNTY DETAILS AND SPECIFICATIONS.

#### VII. WATER NOTES

1. ALL LABOR AND MATERIALS SHALL MEET REQUIREMENTS OF THE COUNTY OF SAN MATEO.

2. COUNTY OF SAN MATEO INSPECTOR MUST BE NOTIFIED, AT LEAST TWO
(2) FULL WORKING DAYS PRIOR TO EXCAVATING OR CONNECTING TO EXISTING
WATER SYSTEM. ONLY THE COUNTY SHALL OPERATE EXISTING SYSTEM
VAI VFS

3. STANDARD THRUST BLOCK SHALL BE PROVIDED AT ALL BENDS GREATER THAN 10 DEGREES AND AT ALL CROSSES, TEE, WYES, CAPS, PLUGS, VALVES

4. PROVIDE 36" MINIMUM COVER FROM ROADWAY SURFACE OVER MAINS; MAINTAIN AN ONE FOOT (1') MINIMUM VERTICAL CLEARANCE FROM NEW WATER MAIN TO OTHER CROSSINGS UTILITIES, AND A FIVE FOOT (5') MINIMUM HORIZONTAL CLEARANCE FROM OTHER UTILITY MAINS. WATER MAINS SHALL BE INSTALLED ABOVE, AND A TEN FOOT (10') MINIMUM DISTANCE AWAY FROM, SANITARY SEWERS.

5. CONTRACTOR SHALL USE HAND TOOLS WHEN EXCAVATING NEAR ALL WATER, SEWER, STORM, GAS, ELECTRIC, COMMUNICATION AND CABLE LINES.

6. ALL TAPPED CONNECTIONS (DOMESTIC AND FIRE) SHALL BE "WET-TAPPED". WET TAPS WILL BE PERFORMED BY THE COUNTY OF SAN MATEO AT THE CONTRACTOR'S EXPENSE. CONTRACTOR SHALL FURNISH AND INSTALL SMITH BLAIR 663-316SS, ALL 316 STAINLESS STEEL TAPPING SLEEVE, MUELLER FLANGE X MECHANICAL JOINT TAPPING VALVE, OR APPROVED EQUAL; PER COUNTY STANDARDS, AND DO ALL EXCAVATING, INSTALLING THRUST BLOCKS AND BACKFILLING.

7. COMPACTION, TESTING AND INSPECTION COSTS SHALL BE PAID FOR BY

8. PRESSURE, CHLORINATION AND LEAKAGE TESTS SHALL BE PERFORMED BY CONTRACTOR. SAMPLING POINTS WILL BE SELECTED BY THE COUNTY. BACTERIOLOGICAL TESTS SHALL BE PERFORMED BY AN APPROVED COMMERCIAL TESTING LABORATORY. BACTERIOLOGICAL AND DISINFECTION TESTS SHALL BE PAID FOR BY THE OWNER, DEVELOPER, OR CONTRACTOR.

9. CONTRACTOR SHALL CONTACT ENGINEERING AND CONSTRUCTION FOR AN ESTIMATED COST OF WATER METER AND WET TAP.10. METERS ARE INSTALLED BY THE COUNTY OF SAN MATEO UPON

PAYMENT OF METER CHARGE BY OWNER/DEVELOPER.

11. ABANDONMENT OF EXISTING WATER LINES SHALL TAKE PLACE AT THE

12. THE CONTRACTOR SHALL BE RESPONSIBLE FOR LOCATING SERVICES FOR THOSE FACILITIES TO BE INSTALLED BY THE CONTRACTOR UNTIL SUCH TIME AS THE WORK HAS BEEN OFFICIALLY ACCEPTED BY THE ENGINEER. THE MARKING, LABELING AND TIMING OF SUCH LOCATIONS SHALL BE IN CONFORMANCE WITH THE REQUIREMENTS OF UNDERGROUND SERVICE ALERT.

14. ON-SITE LANDSCAPE IRRIGATION SYSTEMS SHALL BE IN ACCORDANCE WITH THE LANDSCAPE ARCHITECTURAL PLANS AND SPECIFICATIONS AND SHALL BE CONNECTED TO THE EXISTING AND/OR NEW WATER SYSTEM.

#### VIII. SANITARY SEWER NOTES

1. THE ON-SITE PRIVATE SANITARY SEWER SYSTEM SHALL BE INSTALLED BY THE CONTRACTOR IN ACCORDANCE WITH THESE PLANS AND COUNTY DETAILS AND SPECIFICATIONS

#### IX. RECORD DRAWINGS

1. CONTRACTOR SHALL KEEP ACCURATE AS-BUILT DRAWINGS WHICH SHOW THE FINAL LOCATION, ELEVATION AND DESCRIPTION OF WORK. CONTRACTOR SHALL ALSO NOTE THE LOCATION AND ELEVATION OF EXISTING IMPROVEMENTS ENCOUNTERED. RECORD DRAWINGS SHALL BE "REDLINED" ON A SET OF PRINTS. THE REDLINED PRINTS SHALL BE DELIVERED TO THE OWNER AFTER THE COMPLETION OF CONSTRUCTION.

## X. STATEMENT OF RESPONSIBILITY

1. CONSTRUCTION CONTRACTOR AGREES THAT IN ACCORDANCE WITH GENERALLY ACCEPTED CONSTRUCTION PRACTICES, CONSTRUCTION CONTRACTOR WILL BE REQUIRED TO ASSUME SOLE AND COMPLETE RESPONSIBILITY FOR JOB SITE CONDITIONS DURING THE COURSE OF CONSTRUCTION OF THE PROJECT, INCLUDING SAFETY OF ALL PERSONS AND PROPERTY. THIS REQUIREMENT SHALL BE MADE TO APPLY CONTINUOUSLY AND NOT BE LIMITED TO NORMAL WORKING HOURS, AND CONSTRUCTION CONTRACTOR FURTHER AGREES TO DEFEND, INDEMNIFY AND HOLD DESIGN PROFESSIONAL HARMLESS FROM ANY AND ALL LIABILITY, REAL OR ALLEGED, IN CONNECTION WITH THE PERFORMANCE OF WORK ON THIS PROJECT, EXCEPTING LIABILITY ARISING FROM THE SOLE NEGLIGENCE OF THE DESIGN PROFESSIONAL.

2. CONTRACTOR SHALL COMPLY WITH STATE, COUNTY AND CITY LAWS AND ORDINANCES; AND REGULATIONS OF THE DEPARTMENT OF INDUSTRIAL RELATIONS, OSHA AND INDUSTRIAL ACCIDENT COMMISSION RELATING TO SAFETY AND CHARACTER OF WORK, EQUIPMENT AND LABOR PERSONNEL.

## XI. UNAUTHORIZED CHANGES AND USES

1. THE CIVIL DESIGN ENGINEER PREPARING THESE PLANS WILL NOT BE RESPONSIBLE FOR, OR LIABLE FOR, UNAUTHORIZED CHANGES TO OR USES OF THESE PLANS. CHANGES TO THE PLANS MUST BE IN WRITING AND MUST BE APPROVED BY THE PREPARER OF THESE PLANS.

# **ABBREVIATIONS**

AB	AGGREGATE BASE	FOB	FACE OF BUILDING	P.S.S.E.	PRIVATE SANITARY
AC	ASPHALT CONCRETE	FOC	FACE OF CURB	55	SEWER EASEMENT
ACC	ACCESSIBLE	FS	FINISH SURFACE	P.U.E.	PUBLIC UTILITY EASEMENT
ACP	ASBESTOS CEMENT PIPE	G	GAS	PVC	POLYVINYL CHLORIDE PIPE
AD	AREA DRAIN	GB	GRADE BREAK	R	RIGHT/RADIUS
ALT	ALTERNATIVE	GR	GRATE	RCP	REINFORCED CONCRETE PIPE
BC	BACK OF CURB	GRD	GROUND	RPA	REDUCED PRESSURE ASSEMBLY
BFE	BASE FLOOD ELEVATION	GS	GARAGE SLAB	R/W	RIGHT-OF-WAY
BFP	BACKFLOW PREVENTER	GYW	GUY WIRE	RWD	REDWOOD
BLDG	BUILDING	HAG	HIGHEST ADJACENT GRADE	S	SLOPE/SOUTH
BOT	BOTTOM	HP	HIGH POINT	SD	STORM DRAIN
BW	BACK OF WALK	I.E.E.	INGRESS, EGRESS EASEMENT	SDMH	STORM DRAIN MANHOLE
CB	CATCH BASIN	INV	INVERT (ELEVATION)	SF	SQUARE FEET
CI	CURB INLET	IRR	IRRIGATION	SHT	SHEET
CIP	CAST IRON PIPE	JP	JOINT UTILITY POLE	S/L	STREET LIGHT
C&G	CURB AND GUTTER	JT	JOINT UTILITY TRENCH	SLB	STREET LIGHT BOX
倬, CL	CENTERLINE	L	LEFT/LENGTH	SLD	SEE LANDSCAPE DRAWINGS
CLF	CHAIN LINK FENCE	LAG	LOWEST ADJACENT GRADE	SL	STREET LIGHT CONDUIT
CO	CLEANOUT	LAT	LATERAL	SS	SANITARY SEWER
CONC	CONCRETE	LF	LINEAL FEET	SSC0	SANITARY SEWER CLEANOUT
CONST	CONSTRUCTION	LG	LIP OF GUTTER	SSMH	SANITARY SEWER MANHOLE
CR	CURB RETURN	LOW	LIMIT OF WORK	ST	STREET
DET/DTL	DETAIL	MG	MATCH GRADE	STD	STANDARD
DIP	DUCTILE IRON PIPE	MH	MANHOLE	S/W	SIDEWALK
D/W	DRIVEWAY	N	NORTH	T, TEL	TELEPHONE
DWG	DRAWING	(N)	NEW	TC	TOP OF CURB
Ε	EAST/ELECTRIC	NTS	NOT TO SCALE	TRC	TOP OF ROLLED CURB
(E),EX	EXISTING	O.D.	OUTSIDE DIMENSION	TSW	TOP OF SCREEN WALL
ELEC	ELECTRIC	OH	OVERHEAD (WIRES)	TW	TOP OF WALL
ELEV	ELEVATION	PB	PULL BOX		TYPICAL
EP	EDGE OF PAVEMENT	PP	POWER POLE	TYP	UNLESS NOTED OTHERWISE
E.V.A.E.	EMERGENCY VEHICLE	(P)	PROPOSED	UNO	UNDERGROUND
	ACCESS EASEMENT	P/L	PROPERTY LINE	UG	
FC	FACE OF CURB	PCC	PORTLAND CEMENT CONCRETE	VCP	VITRIFIED CLAY PIPE
FF	FINISH FLOOR	P/SBC	POWER/SBC TRENCH	W	WATER WEST
FDC	FIRE DEPT CONNECTION	P.F.S.E.	PRIVATE FIRE	WM WV	WATER METER WATER VALVE
FH FL	FIRE HYDRANT FLOWLINE		SERVICE EASEMENT	** *	***************************************
FT	FEET	P.I.E.E.	PRIVATE INGRESS, EGRESS EASEMENT		
			LUNLOS EASEMENT		

P.S.D.E. PRIVATE STORM

DRAIN EASEMENT

PROFESSIONAL CONTROL PROFESSIO

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Project:

COASTSIDE FIRE

PROTECTION DISTRICT FIRE STATION #41

OBISPO ROAD EL GRANADA, CA 94018



Description:

SUBMITTAL

. PLANNING

08/16/16

NOT FOR CONSTRUCTION

Project Number: 20146103

Approved By: SS

Checked By: PC

Drawn By:


Sheet Title:

GENERAL CIVIL NOTES

Sheet: 2 OF 16

Sheet Number:

**C1.0** 

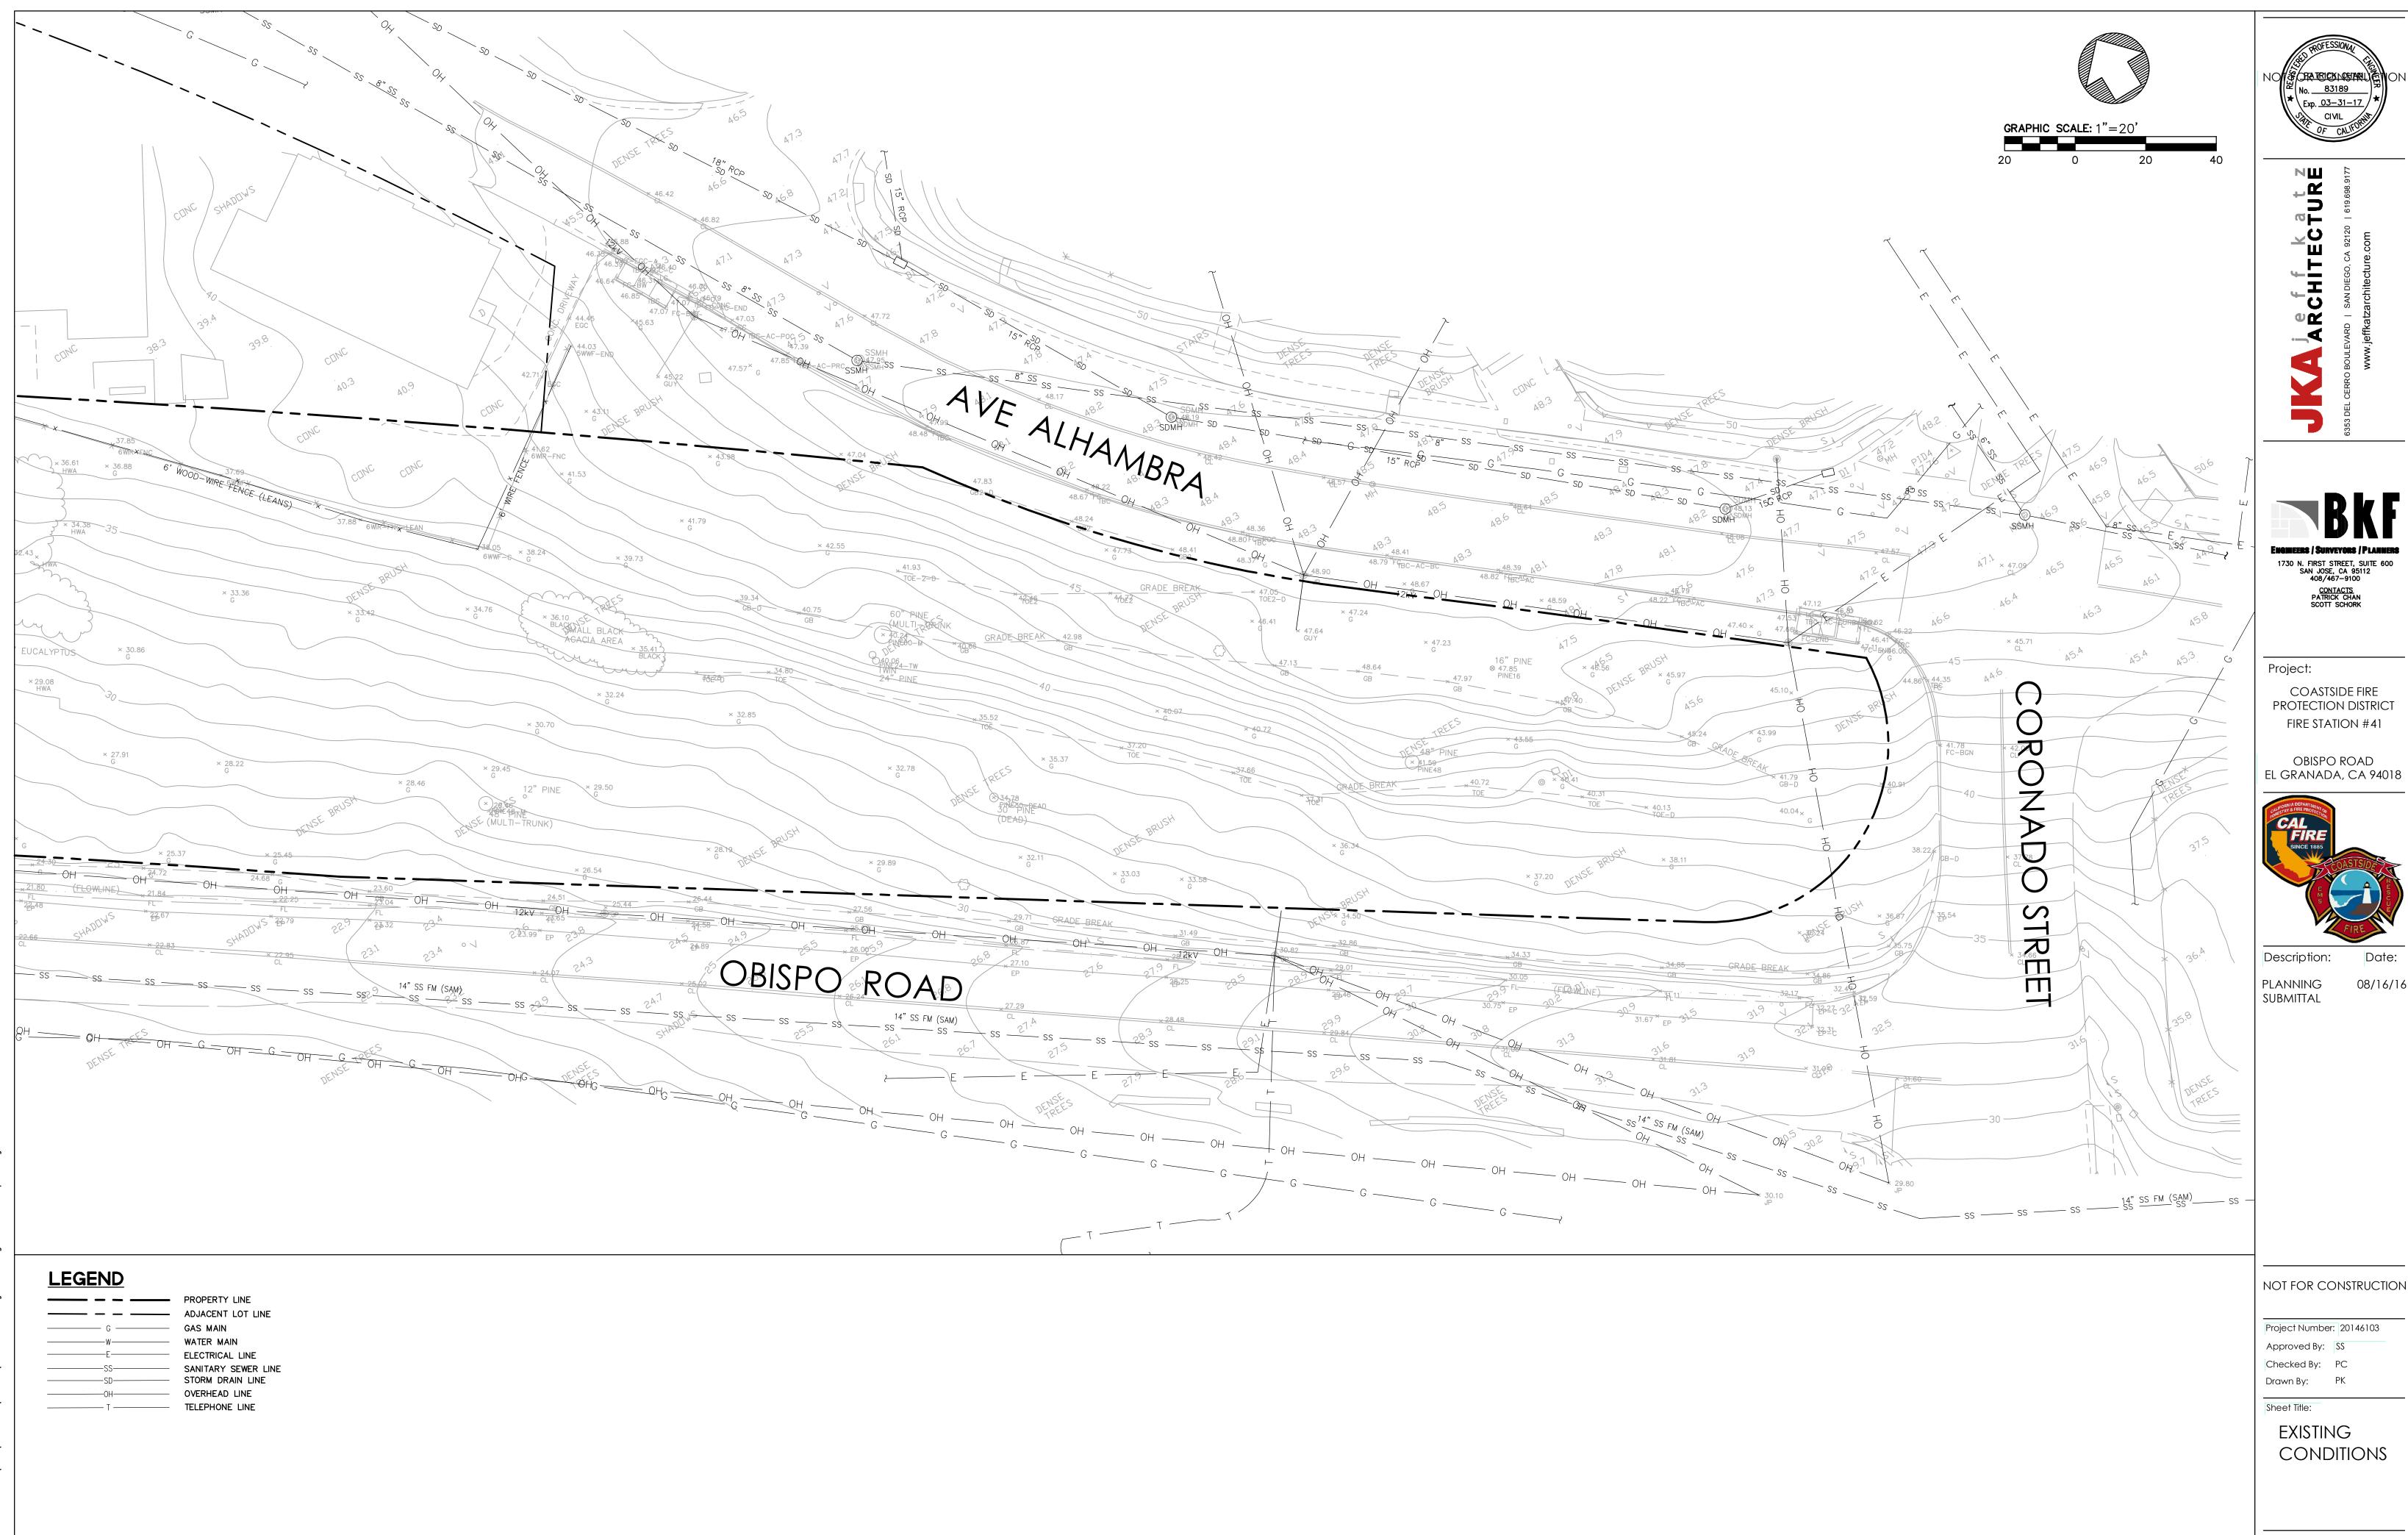


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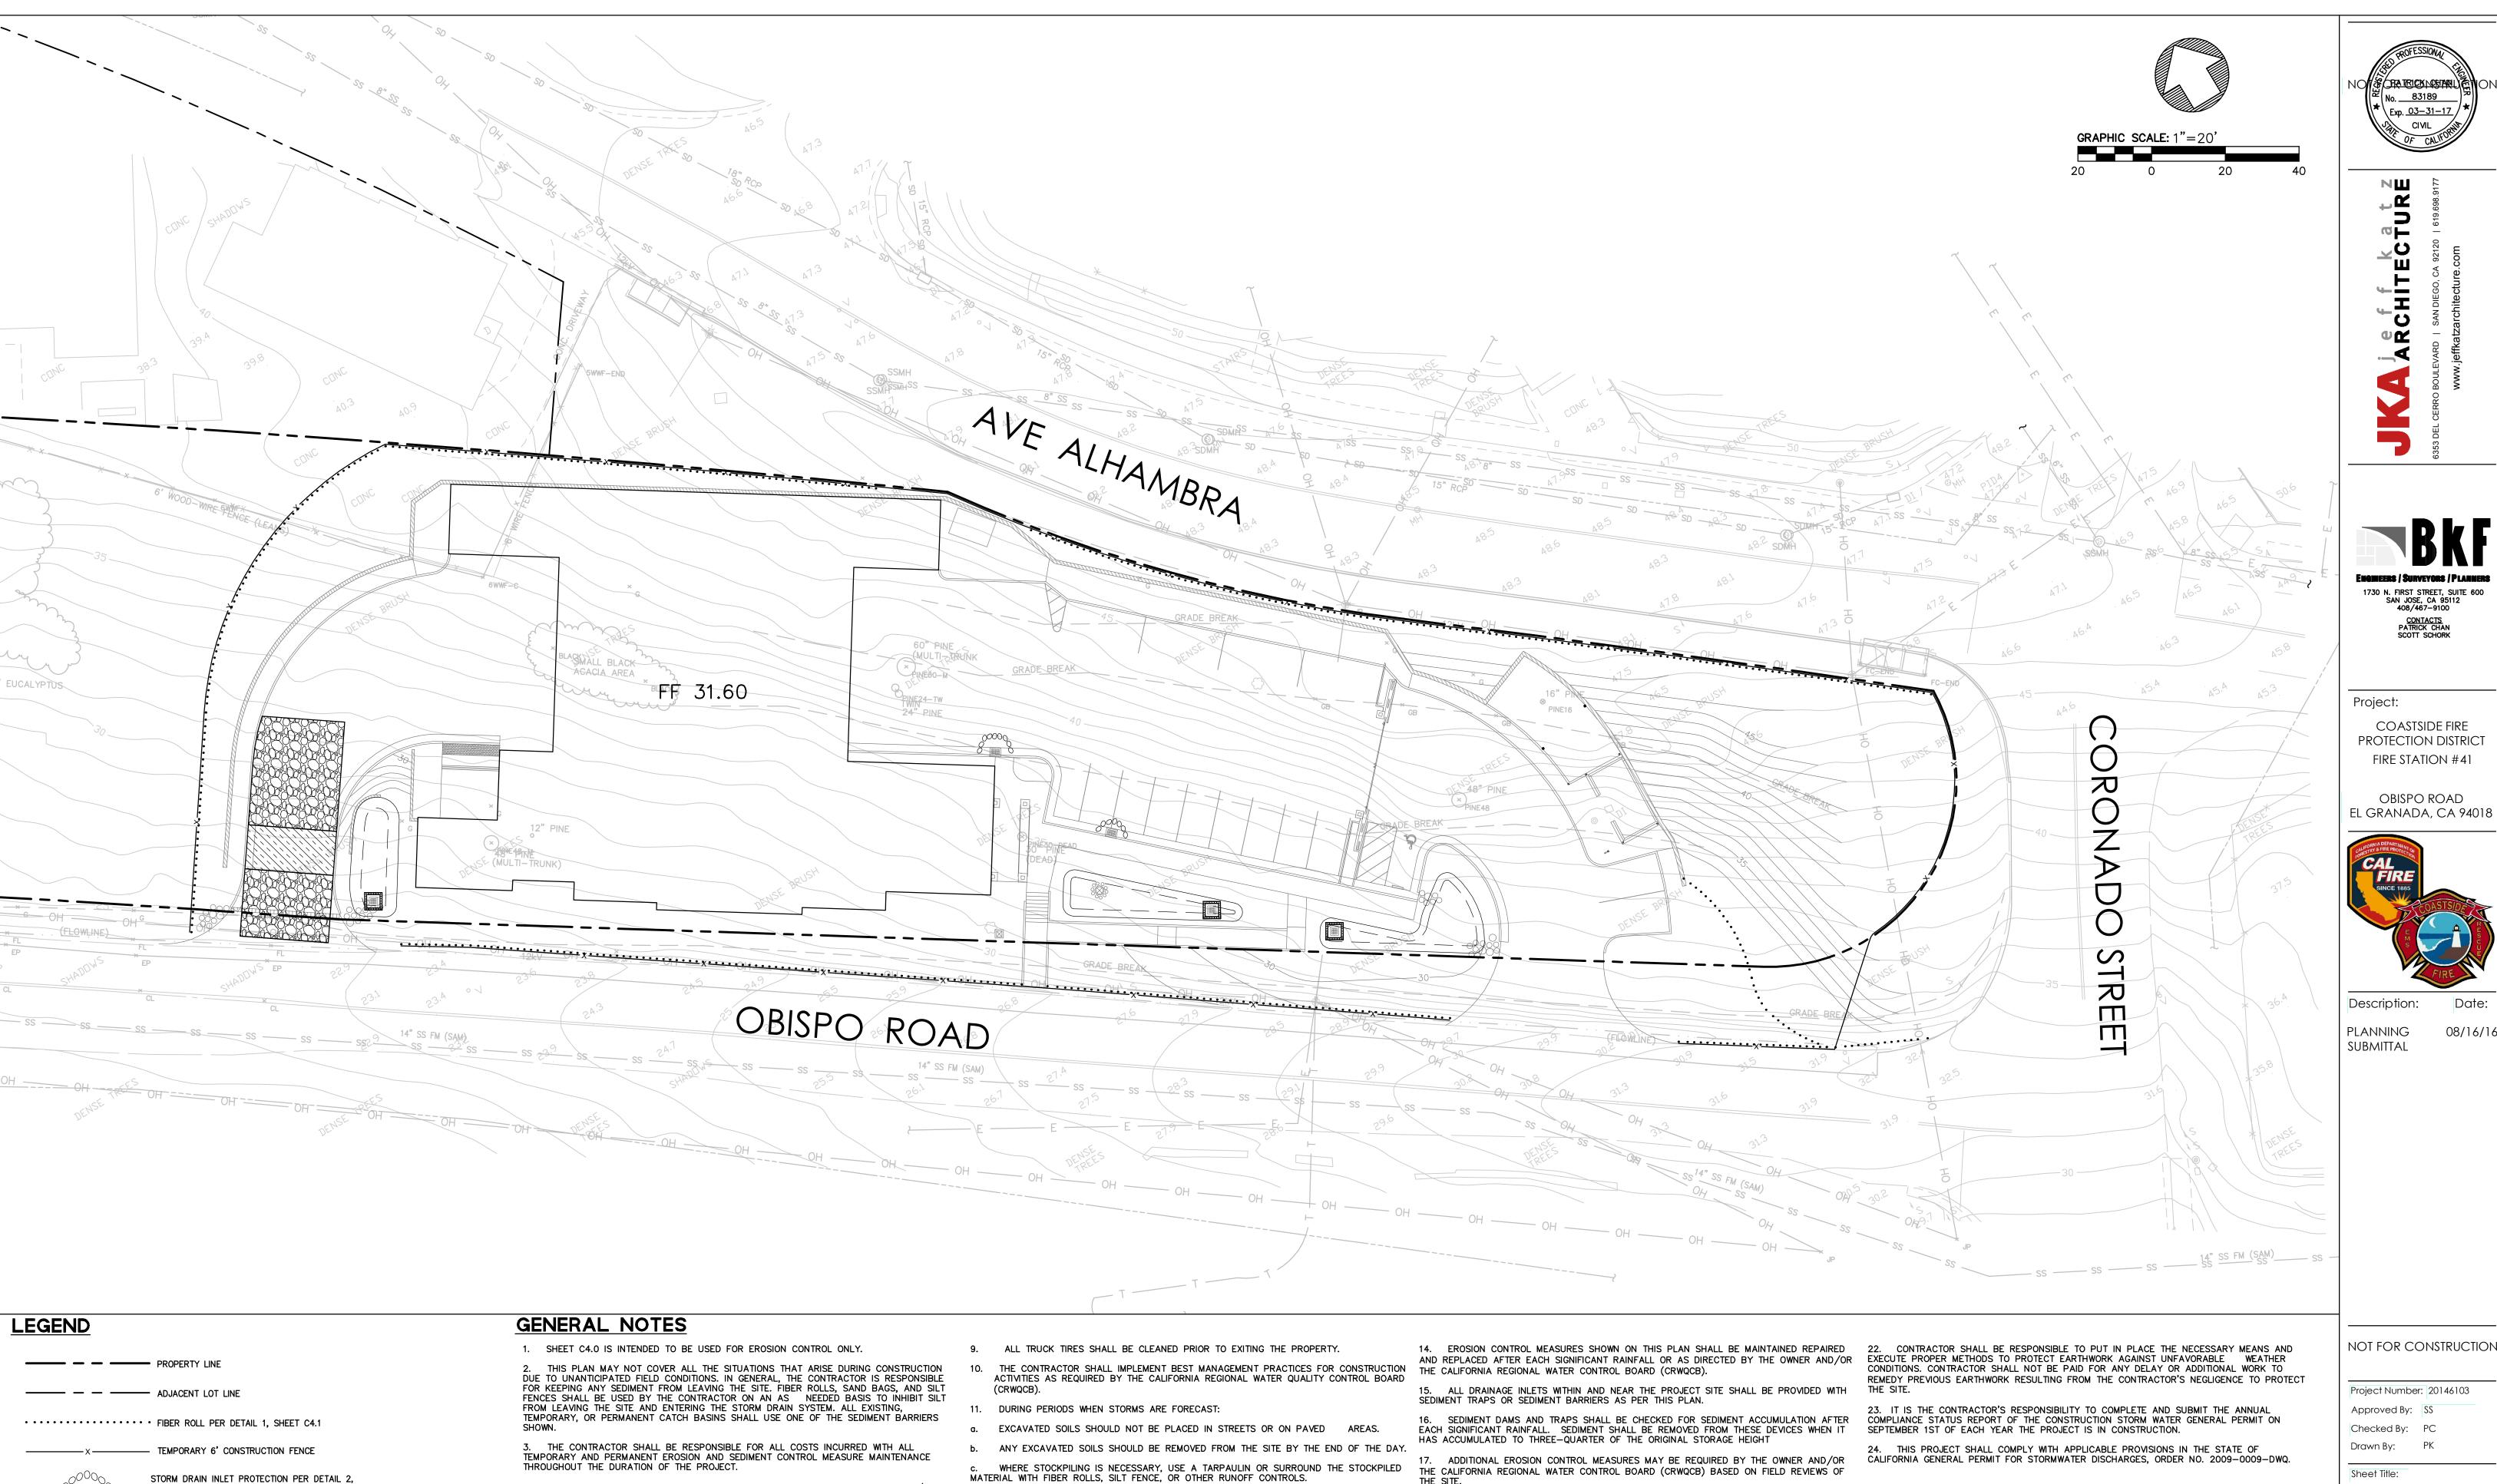




08/16/16

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4. THE CONTRACTOR WILL BE LIABLE FOR ANY AND ALL DAMAGES TO PUBLIC AND/OR PRIVATE OWNED AND MAINTAINED ROAD CAUSED BY THE CONTRACTOR'S GRADING ACTIVITIES, AND WILL BE RESPONSIBLE FOR THE CLEANUP OF ANY MATERIAL SPILLED ON ANY PUBLIC ROAD ON THE HAUL ROUTE. ADJACENT PUBLIC ROADS SHALL BE CLEANED AT THE END OF

SHEET C4.1

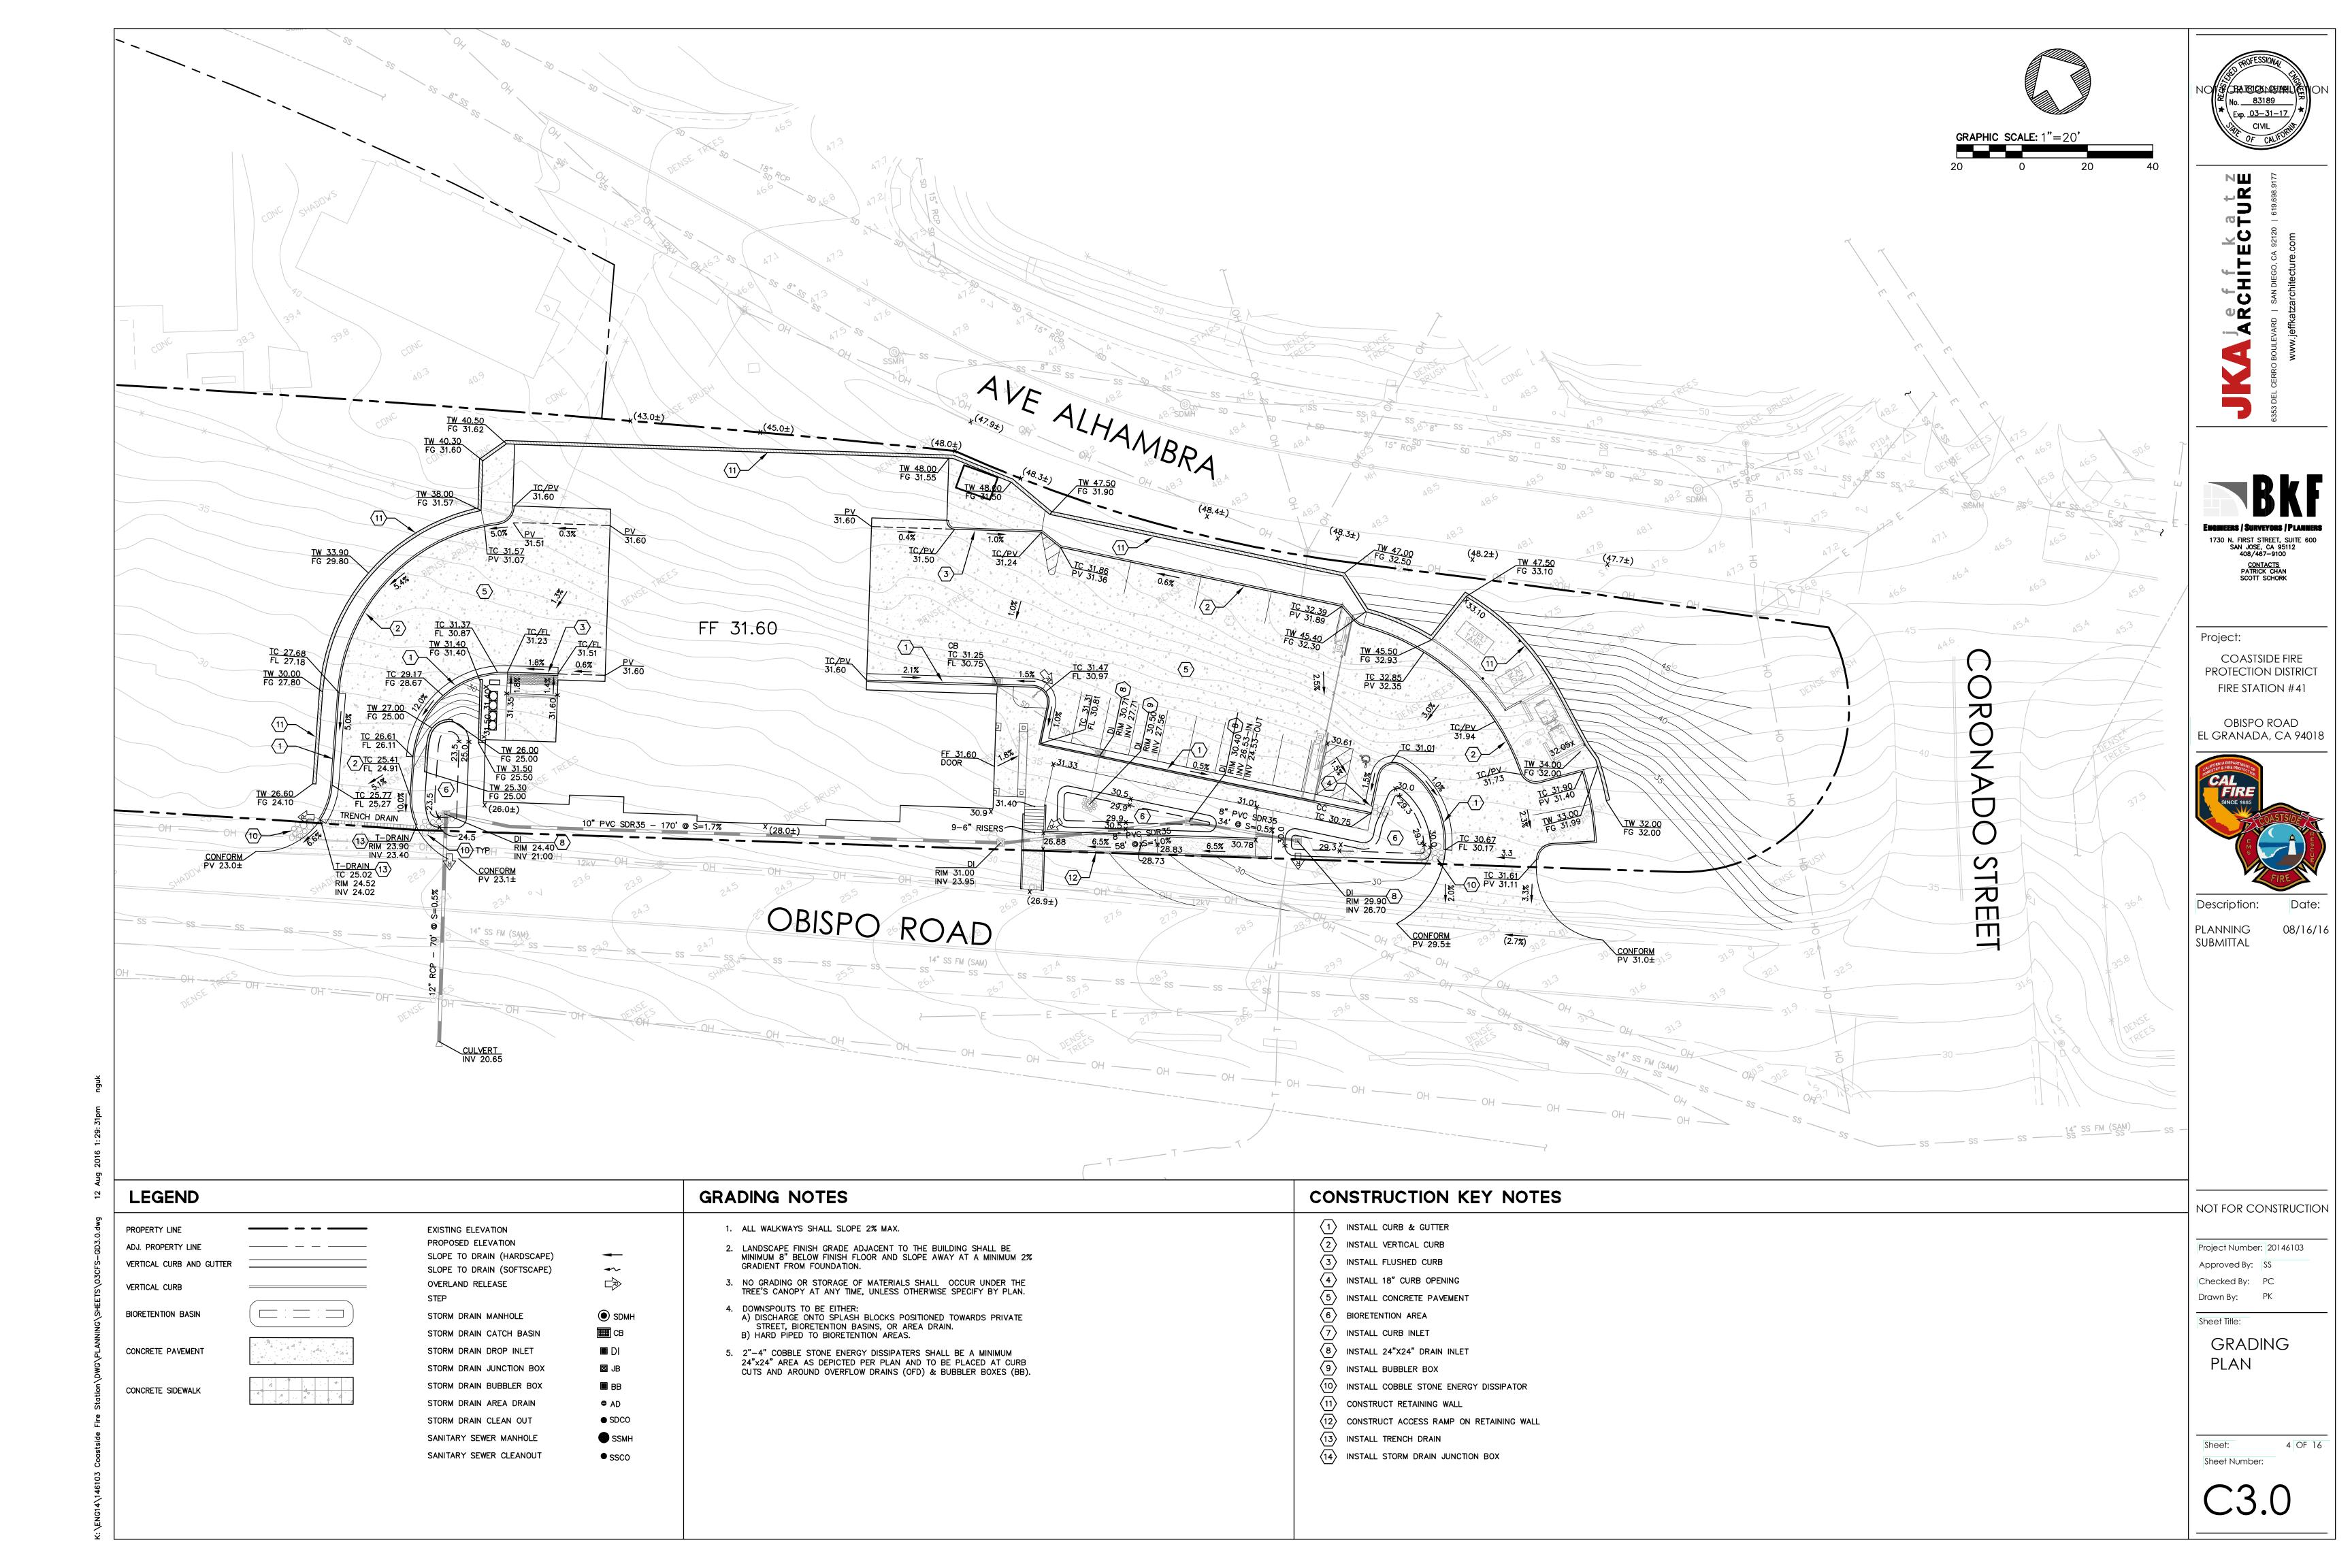SHEET C4.1

SHEET C4.1

CONCRETE

| WASHOUT |

STORM DRAIN INLET PROTECTION PER DETAIL 3,

STABILIZED CONSTRUCTION ENTRANCE/EXIT

CONCRETE WASTE MANAGEMENT PER DETAIL 6

ENTRANCE/EXIT TIRE WASH PER DETAIL 5, SHEET C4.1

PER DETAIL 4, SHEET C4.1

5. EROSION AND SEDIMENT CONTROL MEASURES SHALL BE OPERABLE YEAR ROUND OR UNTIL VEGETATION IS ESTABLISHED ON LANDSCAPED SURFACES.

6. DURING THE RAINY SEASON, ALL PAVED AREAS ARE TO BE KEPT CLEAR OF EARTH MATERIAL AND DEBRIS. THE SITE IS TO BE MAINTAINED SO AS TO MINIMIZE SEDIMENT-LADEN RUNOFF TO ANY STORM DRAIN SYSTEM.

7. ALL EROSION CONTROL FACILITIES MUST BE MONITORED AS REQUIRED BY THE CALIFORNIA REGIONAL WATER QUALITY CONTROL BOARD (CRWQCB). ALL SLOPES SHALL BE REPAIRED AS SOON AS POSSIBLE WHEN DAMAGED.

8. BORROW AND TEMPORARY STOCKPILES SHALL BE PROTECTED WITH APPROPRIATE EROSION CONTROL MEASURES (TARPS, FIBER ROLLS, SILT FENCES, ETC.) TO ENSURE SILT DOES NOT LEAVE THE SITE OR ENTER THE STORM DRAIN SYSTEM

c. WHERE STOCKPILING IS NECESSARY, USE A TARPAULIN OR SURROUND THE STOCKPILED MATERIAL WITH FIBER ROLLS, SILT FENCE, OR OTHER RUNOFF CONTROLS.

USE INLET CONTROLS (E.G. FILTER MAT) FOR STORM DRAINS ADJACENT TO STOCKPILED

THOROUGHLY SWEEP ALL PAVED AREAS EXPOSED TO SOIL EXCAVATION AND

12. DURING PERIODS WHEN STORMS ARE NOT FORECAST -

PREVENT STOCKPILED MATERIAL FROM ENTERING THE STORM DRAIN SYSTEM.

THOROUGHLY REMOVE LOOSE SOIL VIA SWEEPING FOLLOWING REMOVAL OF DIRT.

THIS EROSION CONTROL PLAN IS FOR CONSTRUCTION BETWEEN OCTOBER 1 AND APRIL 15. OPEN SPACE AREAS ARE TO BE PLANTED BY SEPTEMBER 15. IF THESE CONDITIONS ARE NOT MET, CONTRACTOR SHALL SUBMIT AN EROSION CONTROL PLAN TO THE PROJECT ENGINEER THAT REFLECTS CURRENT SITE CONDITIONS FOR REVIEW AND APPROVAL.

18. DAMAGED EROSION CONTROL DEVICES SHALL BE REPAIRED OR REPLACED BY THE CONTRACTOR AS SOON AS PRACTICAL AFTER THE DAMAGE OCCURS.

CRIMPING OR THE APPLICATION OF A LIQUID TACKIFIER.

19. ALL EXPOSED DISTURBED SURFACES SHALL BE HYDROSEEDED WITH BROME SEED SPREAD AT THE RATE OF 5 POUNDS PER 1000 SQUARE FEET, OR APPROVED EQUAL. SEEDING AND WATERING SHALL BE MAINTAINED AS REQUIRED TO ENSURE GROWTH. HYDROSEEDED AREAS SHALL THEN BE COVERED WITH STRAW MULCH AND STABILIZED BY

20. DURING GRADING OPERATIONS THE SITE SHALL BE WATERED ON A DAILY BASIS TO MINIMIZE THE RELEASE OF DUST AND OTHER PARTICULATE MATTER.

21. EARTHWORK SHALL NOT BE PERFORMED DURING UNFAVORABLE CONDITIONS. AFTER INTERRUPTION OF WORK DUE TO HEAVY RAIN, THE ENGINEER SHALL APPROVE EARTHWORK BEFORE RESUMING EARTHMOVING OPERATIONS.


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**EROSION** CONTROL PLAN

08/16/16

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ENTRENCHMENT DETAIL IN SLOPE AREA




ENTRENCHMENT DETAIL IN FLAT AREA
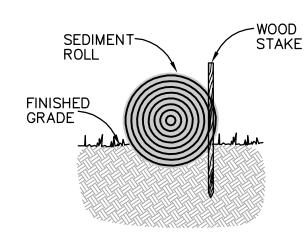
#### NOTES:


- 1. USE REED & GRAHAM, INC. GEOSYNTHETICS STRAW WATTLE FIBER ROLL (COMES IN 9" X 25' ROLLS) OR APPROVED EQUIVALENT.
- FIBER ROLL INSTALLATION REQUIRES THE PLACEMENT AND SECURE STAKING OF THE FIBER ROLL IN A TRENCH, 3" — 5" DEEP, DUG ON CONTOUR.
- 3. RUNOFF MUST NOT BE ALLOWED TO RUN UNDER OR AROUND FIBER ROLL. THE TOP OF THE STRUCTURE (PONDING HEIGHT) MUST BE WELL BELOW THE GROUND ELEVATION DOWNSLOPE TO PREVENT RUNOFF FROM BY—PASSING THE INLET.
- 4. EXCAVATION OF A BASIN ADJACENT TO THE DROP INLET OR A TEMPORARY DIKE ON THE DOWNSLOPE OF THE STRUCTURE MAY BE NECESSARY. IN PAVED AREAS, USE SAND BAGS TO SECURE FIBER ROLLS IN PLACE OF WOOD STAKE.



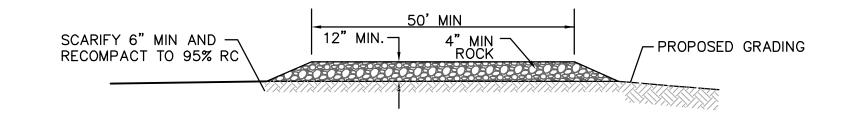


## NOTE

- 1. THE STABILIZED CONSTRUCTION ENTRANCE SHALL BE DESIGNED AND MAINTAINED IAW 2010 CFC, CHAPTER 5, 503.2.3.MVW 45,000 LBS.
- 2. SCARIFY THE TOP 6" OF SUBGRADE AND RECOMPACT TO AT LEAST 95% RELATIVE COMPACTION.
- 3. THE LOCATIONS SHOWN ARE FOR INFORMATION ONLY. CONSTRUCTION ENTRANCES SHALL BE MAINTAINED IN A CONDITION THAT WILL PREVENT TRACKING OR FLOWING OF SEDIMENT ONTO PUBLIC RIGHT-OF-WAYS. THIS MAY REQUIRE PERIODIC TOP DRESSING WITH ADDITIONAL ROCK AS CONDITIONS DEMAND, AND REPAIR AND/OR CLEANOUT OF ANY MEASURES USED TO TRAP SEDIMENT. ALL SEDIMENT SPILLED, DROPPED, WASHED OR TRACKED ONTO PUBLIC RIGHT-OF-WAYS SHALL BE REMOVED IMMEDIATELY.
- 4. WHEELS SHALL BE CLEANED TO REMOVE SEDIMENT PRIOR TO ENTRANCE ONTO PUBLIC RIGHT-OF-WAYS. WHEN WASHING IS REQUIRED, IT SHALL BE DONE ON AN AREA STABILIZED WITH CRUSHED ROCK THAT DRAINS INTO AN APPROVED SEDIMENT TRAP OR SEDIMENT BASIN. SEDIMENT SHALL BE PREVENTED FROM ENTERING THE STORM DRAIN, DITCH OR WATERCOURSE THROUGH USE OF INLET PROTECTION (E.G. GRAVELBAGS OR OTHER APPROVED METHODS).
- 5. THE MATERIAL FOR CONSTRUCTION OF THE PAD SHALL BE 4" MIN ROCK.
- 6. THE THICKNESS OF THE PAD SHALL NOT BE LESS THAN 12". THE WIDTH OF THE PAD SHALL NOT BE LESS THAN THE FULL WIDTH OF ALL POINTS OF INGRESS OR EGRESS, OR 25', WHICHEVER IS LESS.
- 7. THE LENGTH OF THE PAD SHALL NOT BE LESS THAN 50'.

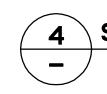


STABILIZED CONSTRUCTION ENTRANCE/EXIT

SCALE: NTS

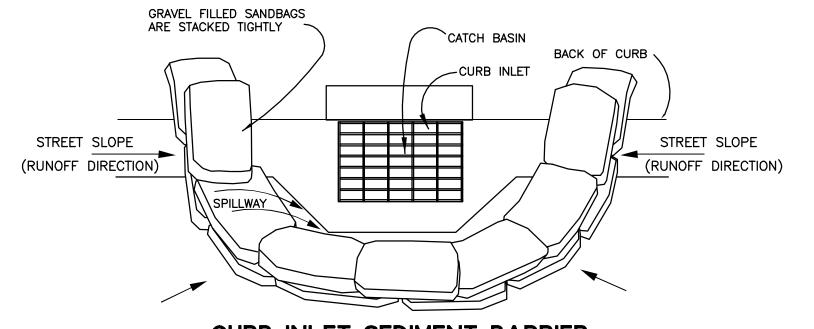

# CURB INLET SEDIMENT BARRIER

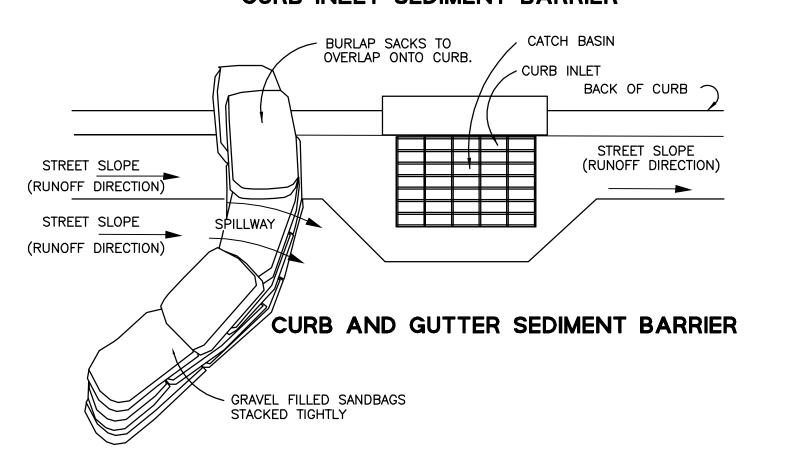


#### NOTES:

- 1. PLACE CURB TYPE SEDIMENT BARRIERS ON GENTLY SLOPING STREETS, WHERE WATER CAN POND AND ALLOW SEDIMENT TO SEPARATE FROM RUNOFF.
- 2. SANDBAGS OF EITHER BURLAP OR WOVEN GEOTEXTILE FABRIC, ARE FILLED
- WITH GRAVEL, LAYERED AND PACKED TIGHTLY


  3. LEAVE ONE SANDBAG GAP IN THE TOP ROW TO PROVIDE A SPILLWAY OVERFLOW.
- TOP OF SPILLWAY SHALL BE LOWER THAN TOP OF CURB.

  4. INSPECT BARRIERS AND REMOVE SEDIMENT AFTER EACH STORM EVENT, SEDIMENT
- AND GRAVEL MUST BE REMOVED FROM THE TRAVELED WAY IMMEDIATELY.



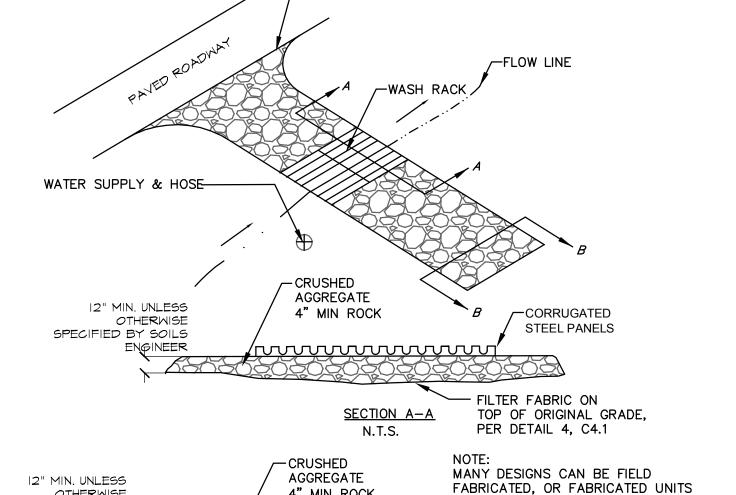



-MATCH EX. GRADE

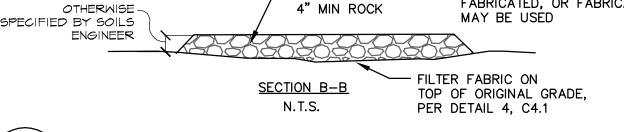

ENTRANCE / OUTLET TIRE WASH

SCALE: NTS

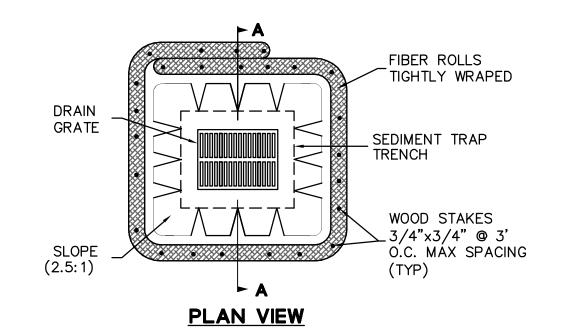

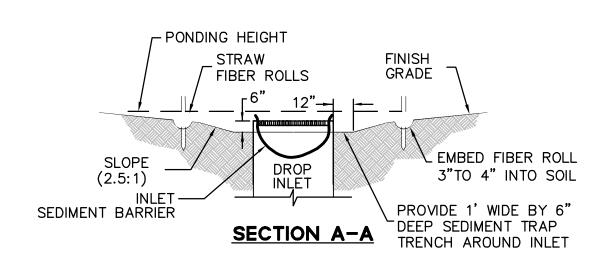


#### NOTE

6

1. PLACE FIBER ROLLS AROUND THE INLET CONSISTENT WITH BASIN SEDIMENT BARRIER DETAIL ON THE SHEET. FIBER ROLLS ARE TUBES MADE FROM STRAW BOUND WITH PLASTIC NETTING. THEY ARE APPROXIMATELY 8" DIAMETER AND 20-30 FEET LONG.



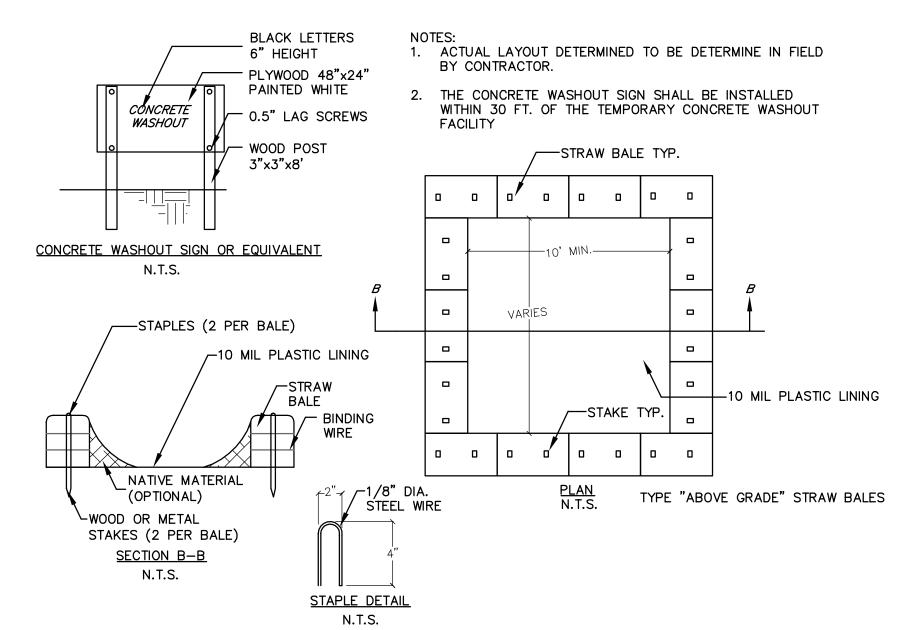

CONCRETE WASTE MANAGEMENT

SCALE: NTS

NO BATRICK NOSTANDLE NO. 83189

Exp. 03-31-17

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CONTACTS
PATRICK CHAN
SCOTT SCHORK

Project:

COASTSIDE FIRE
PROTECTION DISTRICT
FIRE STATION #41

OBISPO ROAD EL GRANADA, CA 94018



Description: D

PLANNING 08/16/16 SUBMITTAL

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Project Number: 20146103

Approved By: SS

Checked By: PC


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Sheet Title:

EROSION CONTROL PLAN

Sheet: 6 OF 16
Sheet Number:

C4.1

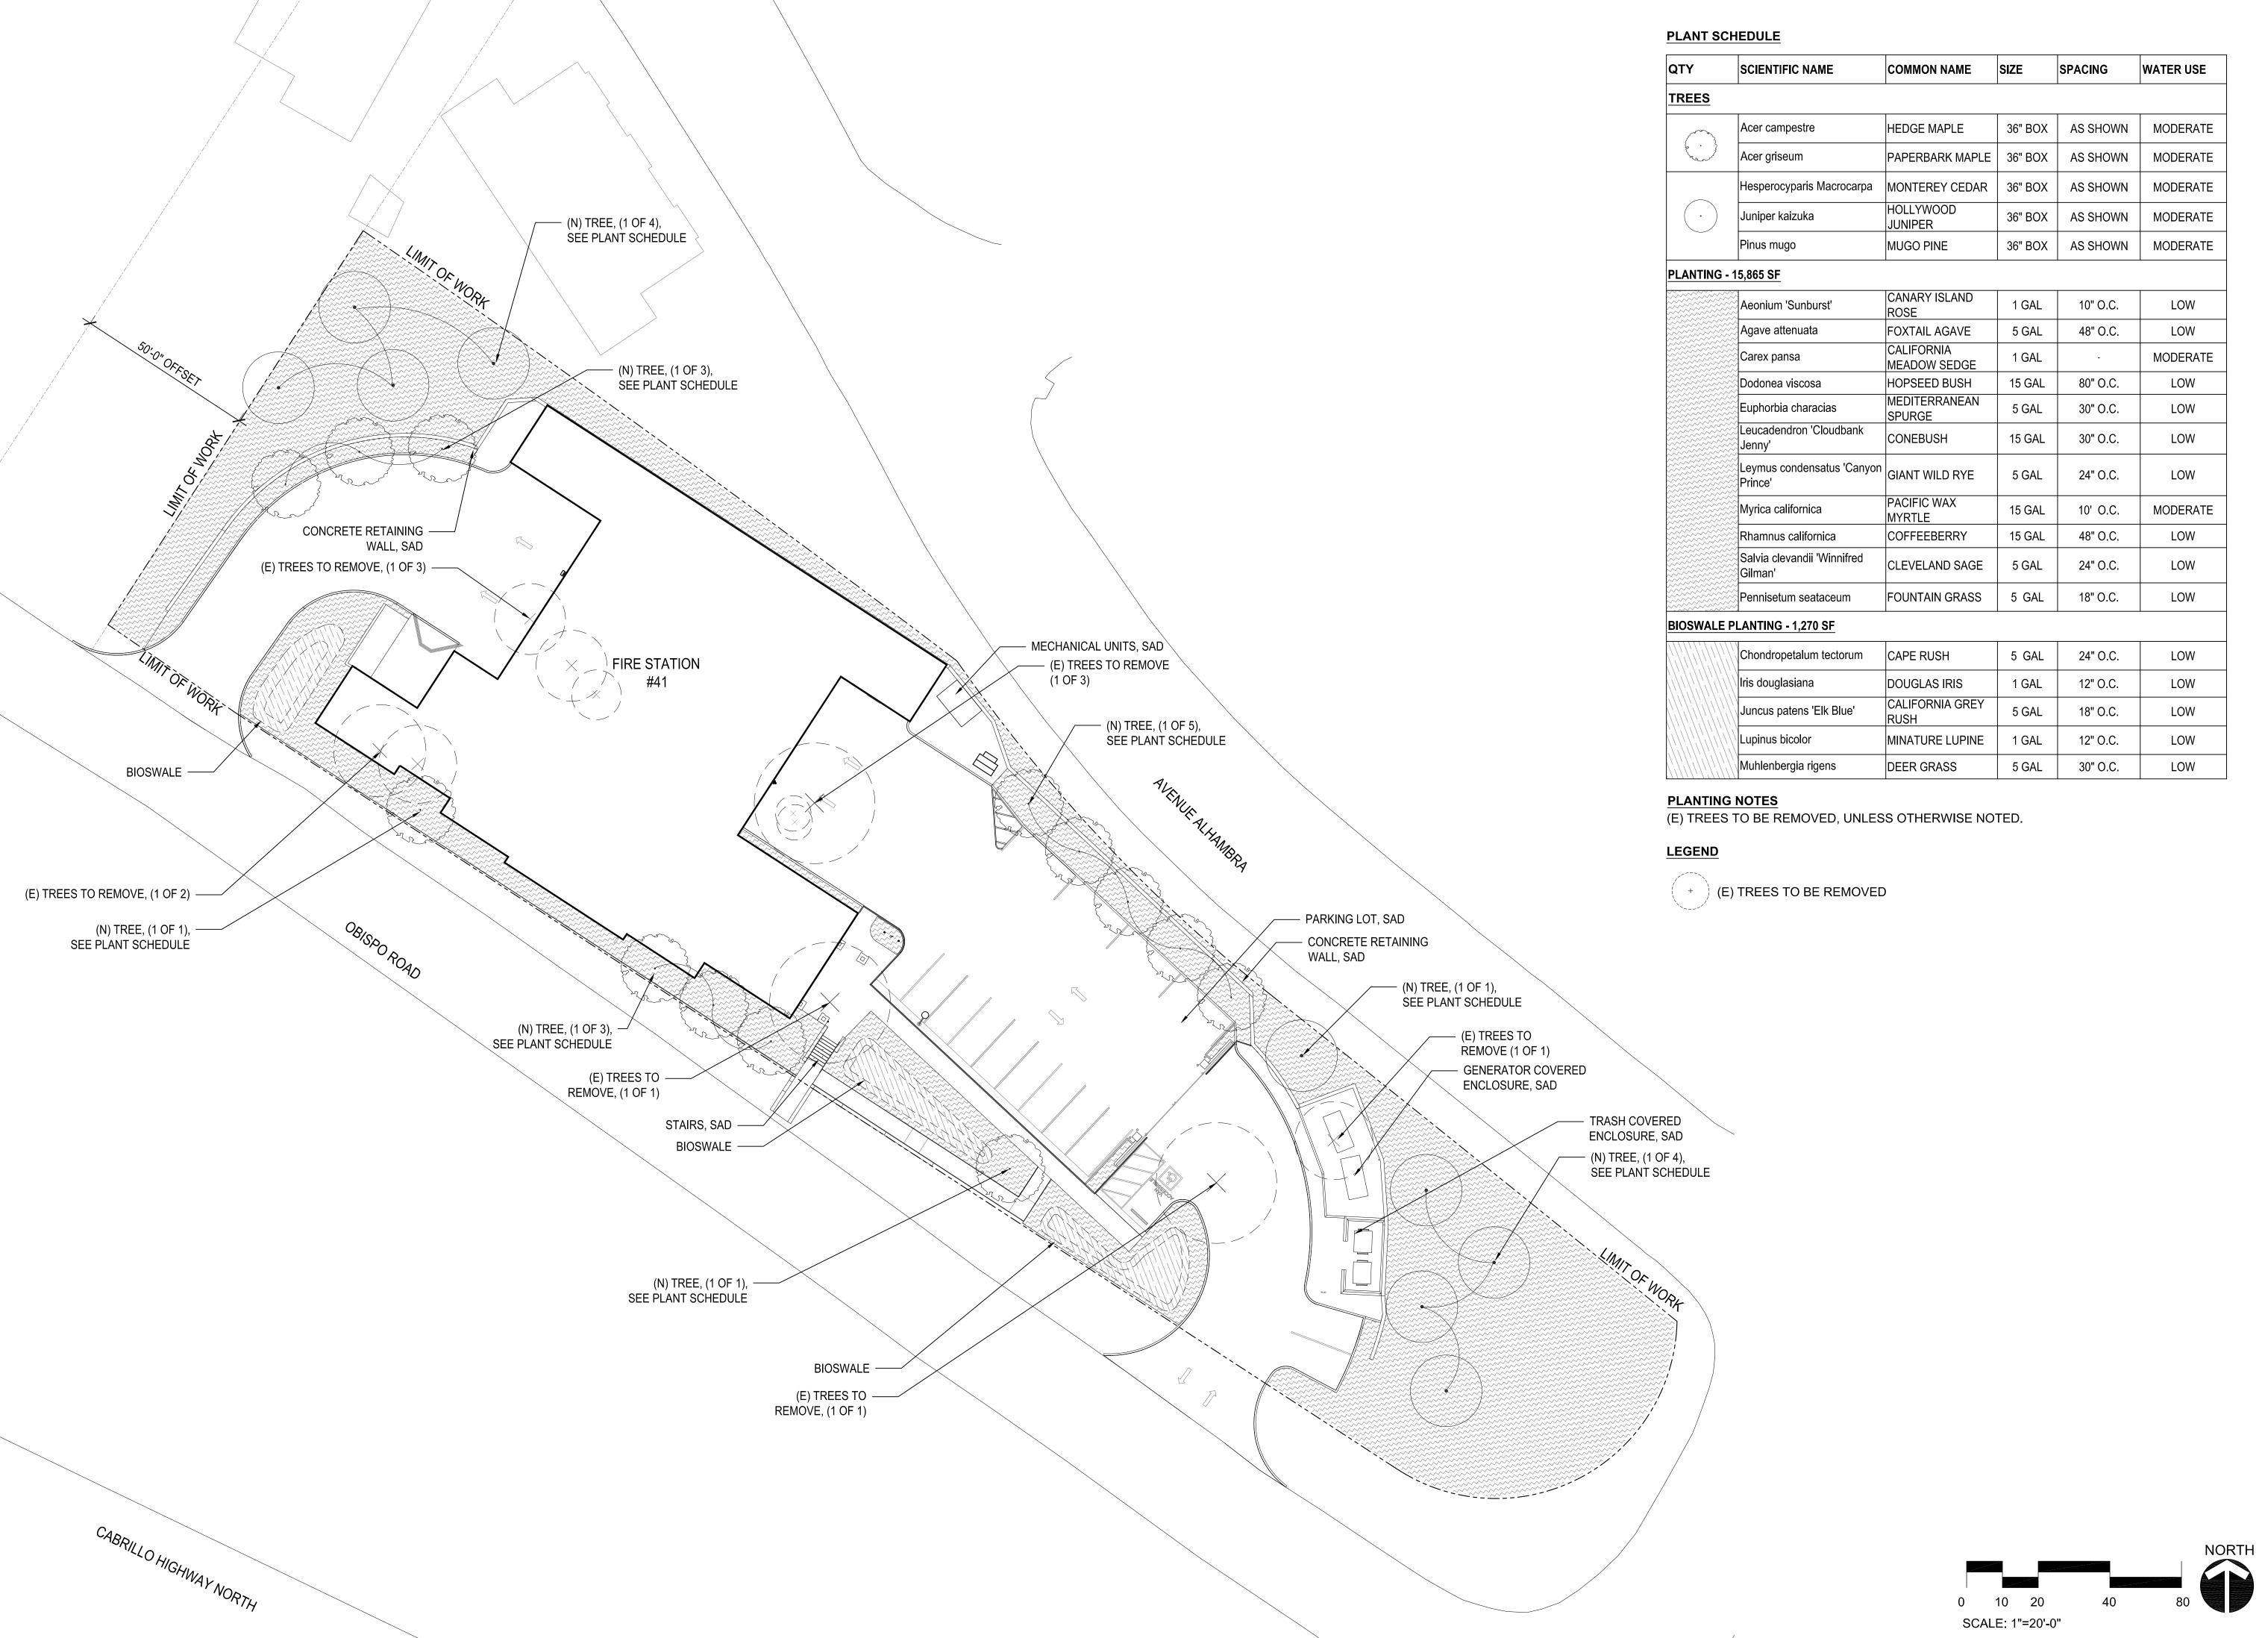

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LANDSCAPE ARCHITECTURE & PLANNING
MILL VALLEY SAN FRANCISCO
225 Miller Avenue, Mill Valley, CA 94941
T 415 383 7900 F 415 383 1433 www.rhaa.com

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OBISPO ROAD EL GRANADA, CA 94018



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Description: Date:

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Project Number: 150202

Approved By: MK

Checked By: JM

Drawn By: AJ


Sheet Title:

LANDSCAPE SITE PLAN

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Sheet: 7 OF 16 Sheet Number:

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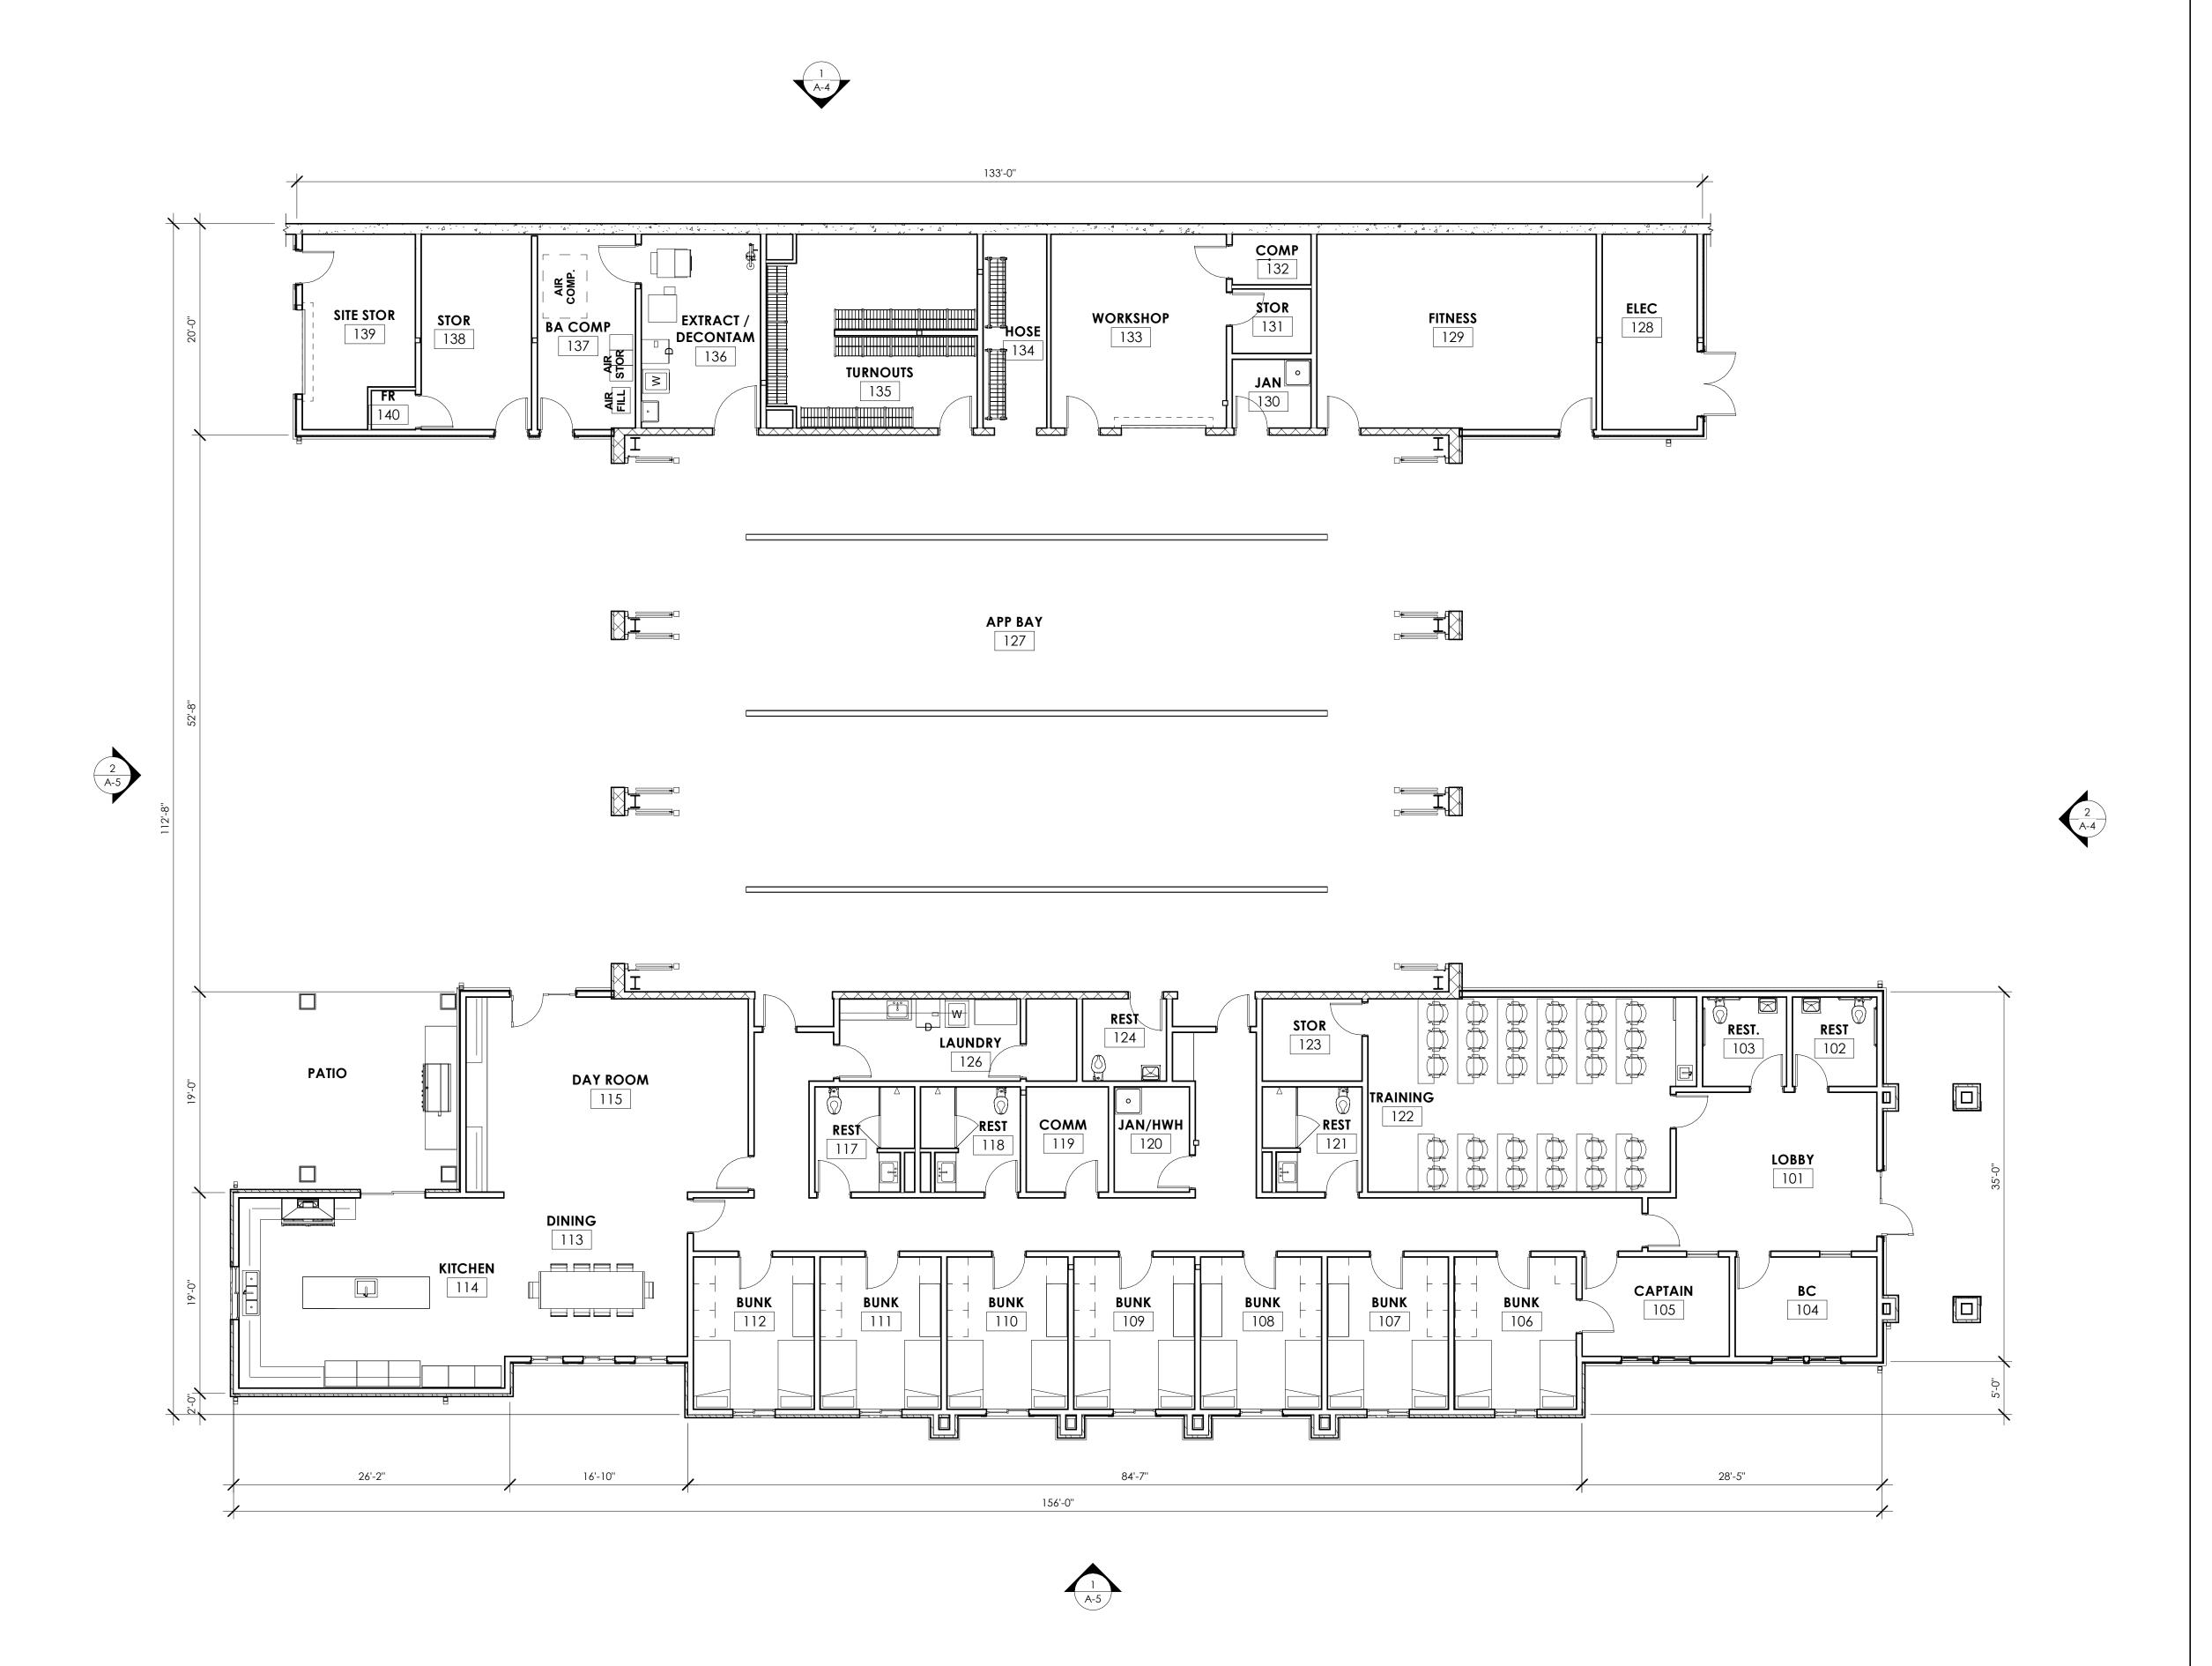
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Sheet Title:

SITE PLAN -PLANNING

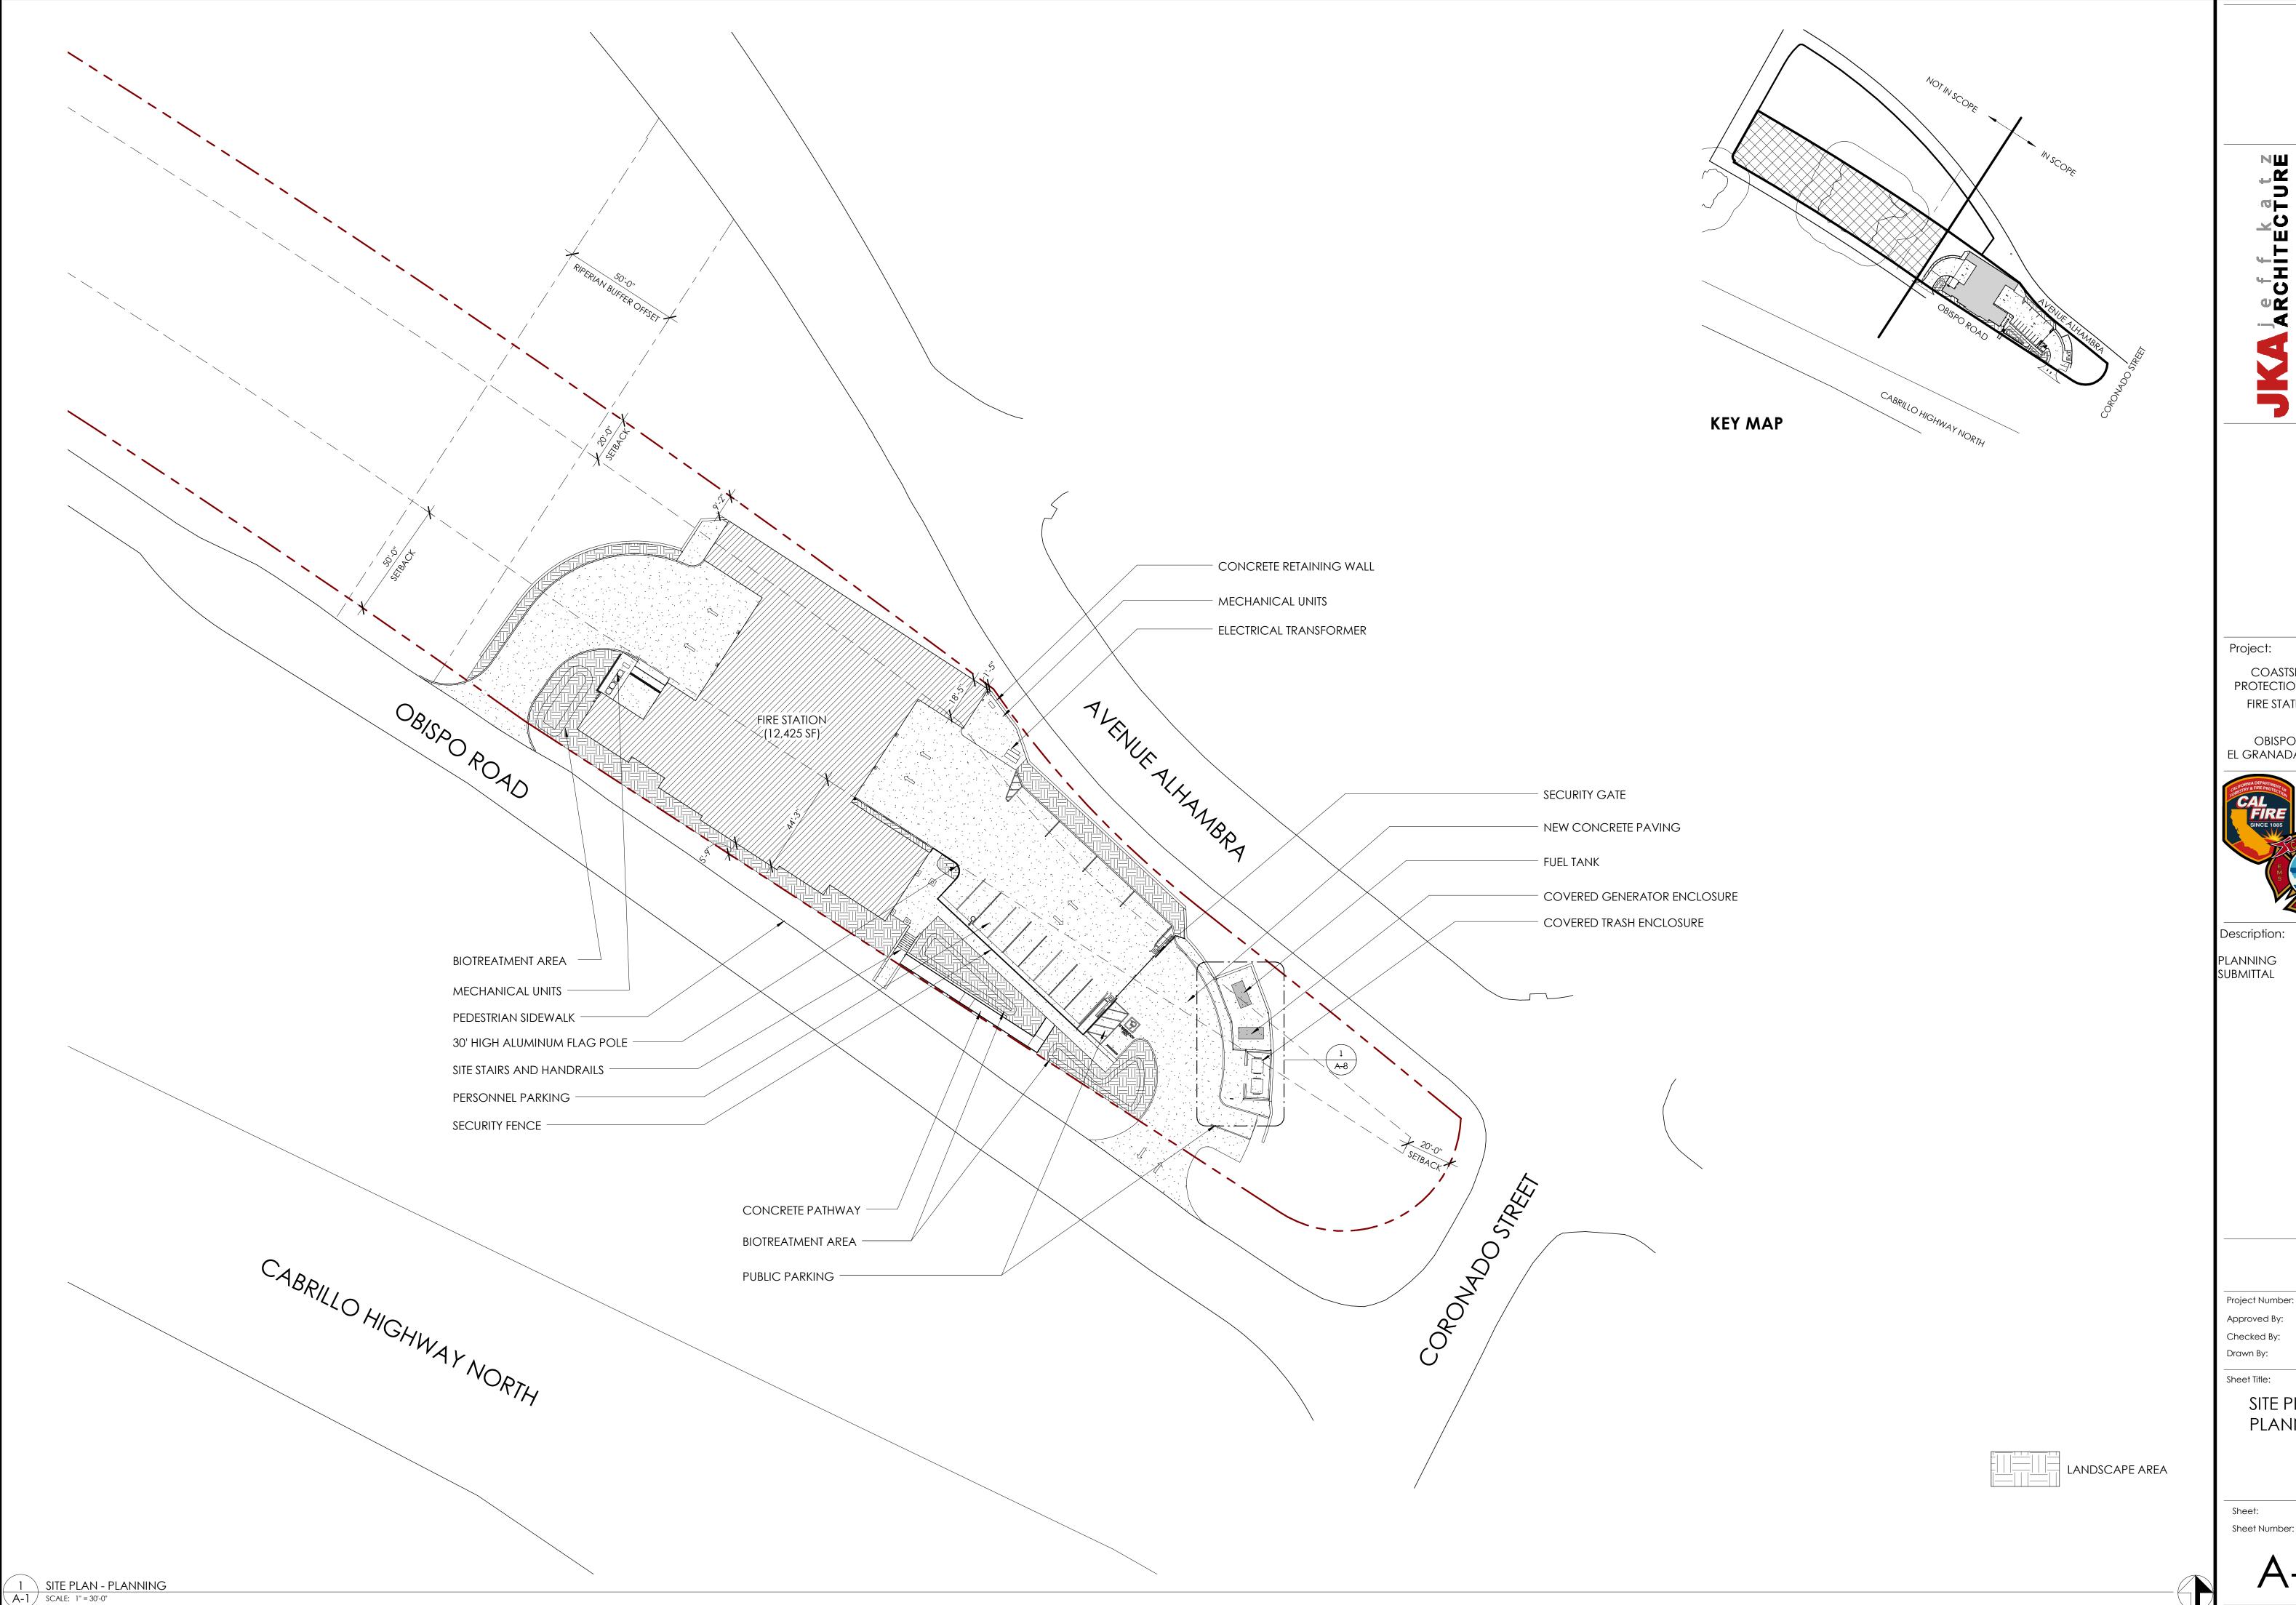8 OF 16



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Description:

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**ROOM AREA SCHEDULE** 

ROOM NAME GROSS AREA CLASS

74 SF

73 SF 138 SF

143 SF

182 SF

180 SF 180 SF

180 SF 180 SF

180 SF

180 SF

284 SF

494 SF

536 SF

703 SF

95 SF

95 SF

84 SF

77 SF

96 SF

80 SF

68 SF

146 SF

4491 SF

182 SF

532 SF 53 SF

50 SF 39 SF

333 SF

121 SF

376 SF

226 SF 187 SF

196 SF 17 SF

12425 SF

598 SF

DINING

KITCHEN

СОММ

TRAINING

LAUNDRY

APP BAY

FITNESS

WORKSHOP

TURNOUTS

SITE STOR

EXTRACT / DECONTAM

TOTAL GROSS AREA

STOR

DAY ROOM

R-3 R-3 R-3

R-3

R-3

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S-2 R-3

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Project Number: 150202 Approved By: Checker Checked By:


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FLOOR PLAN -PLANNING

9 OF 16 Sheet: Sheet Number:





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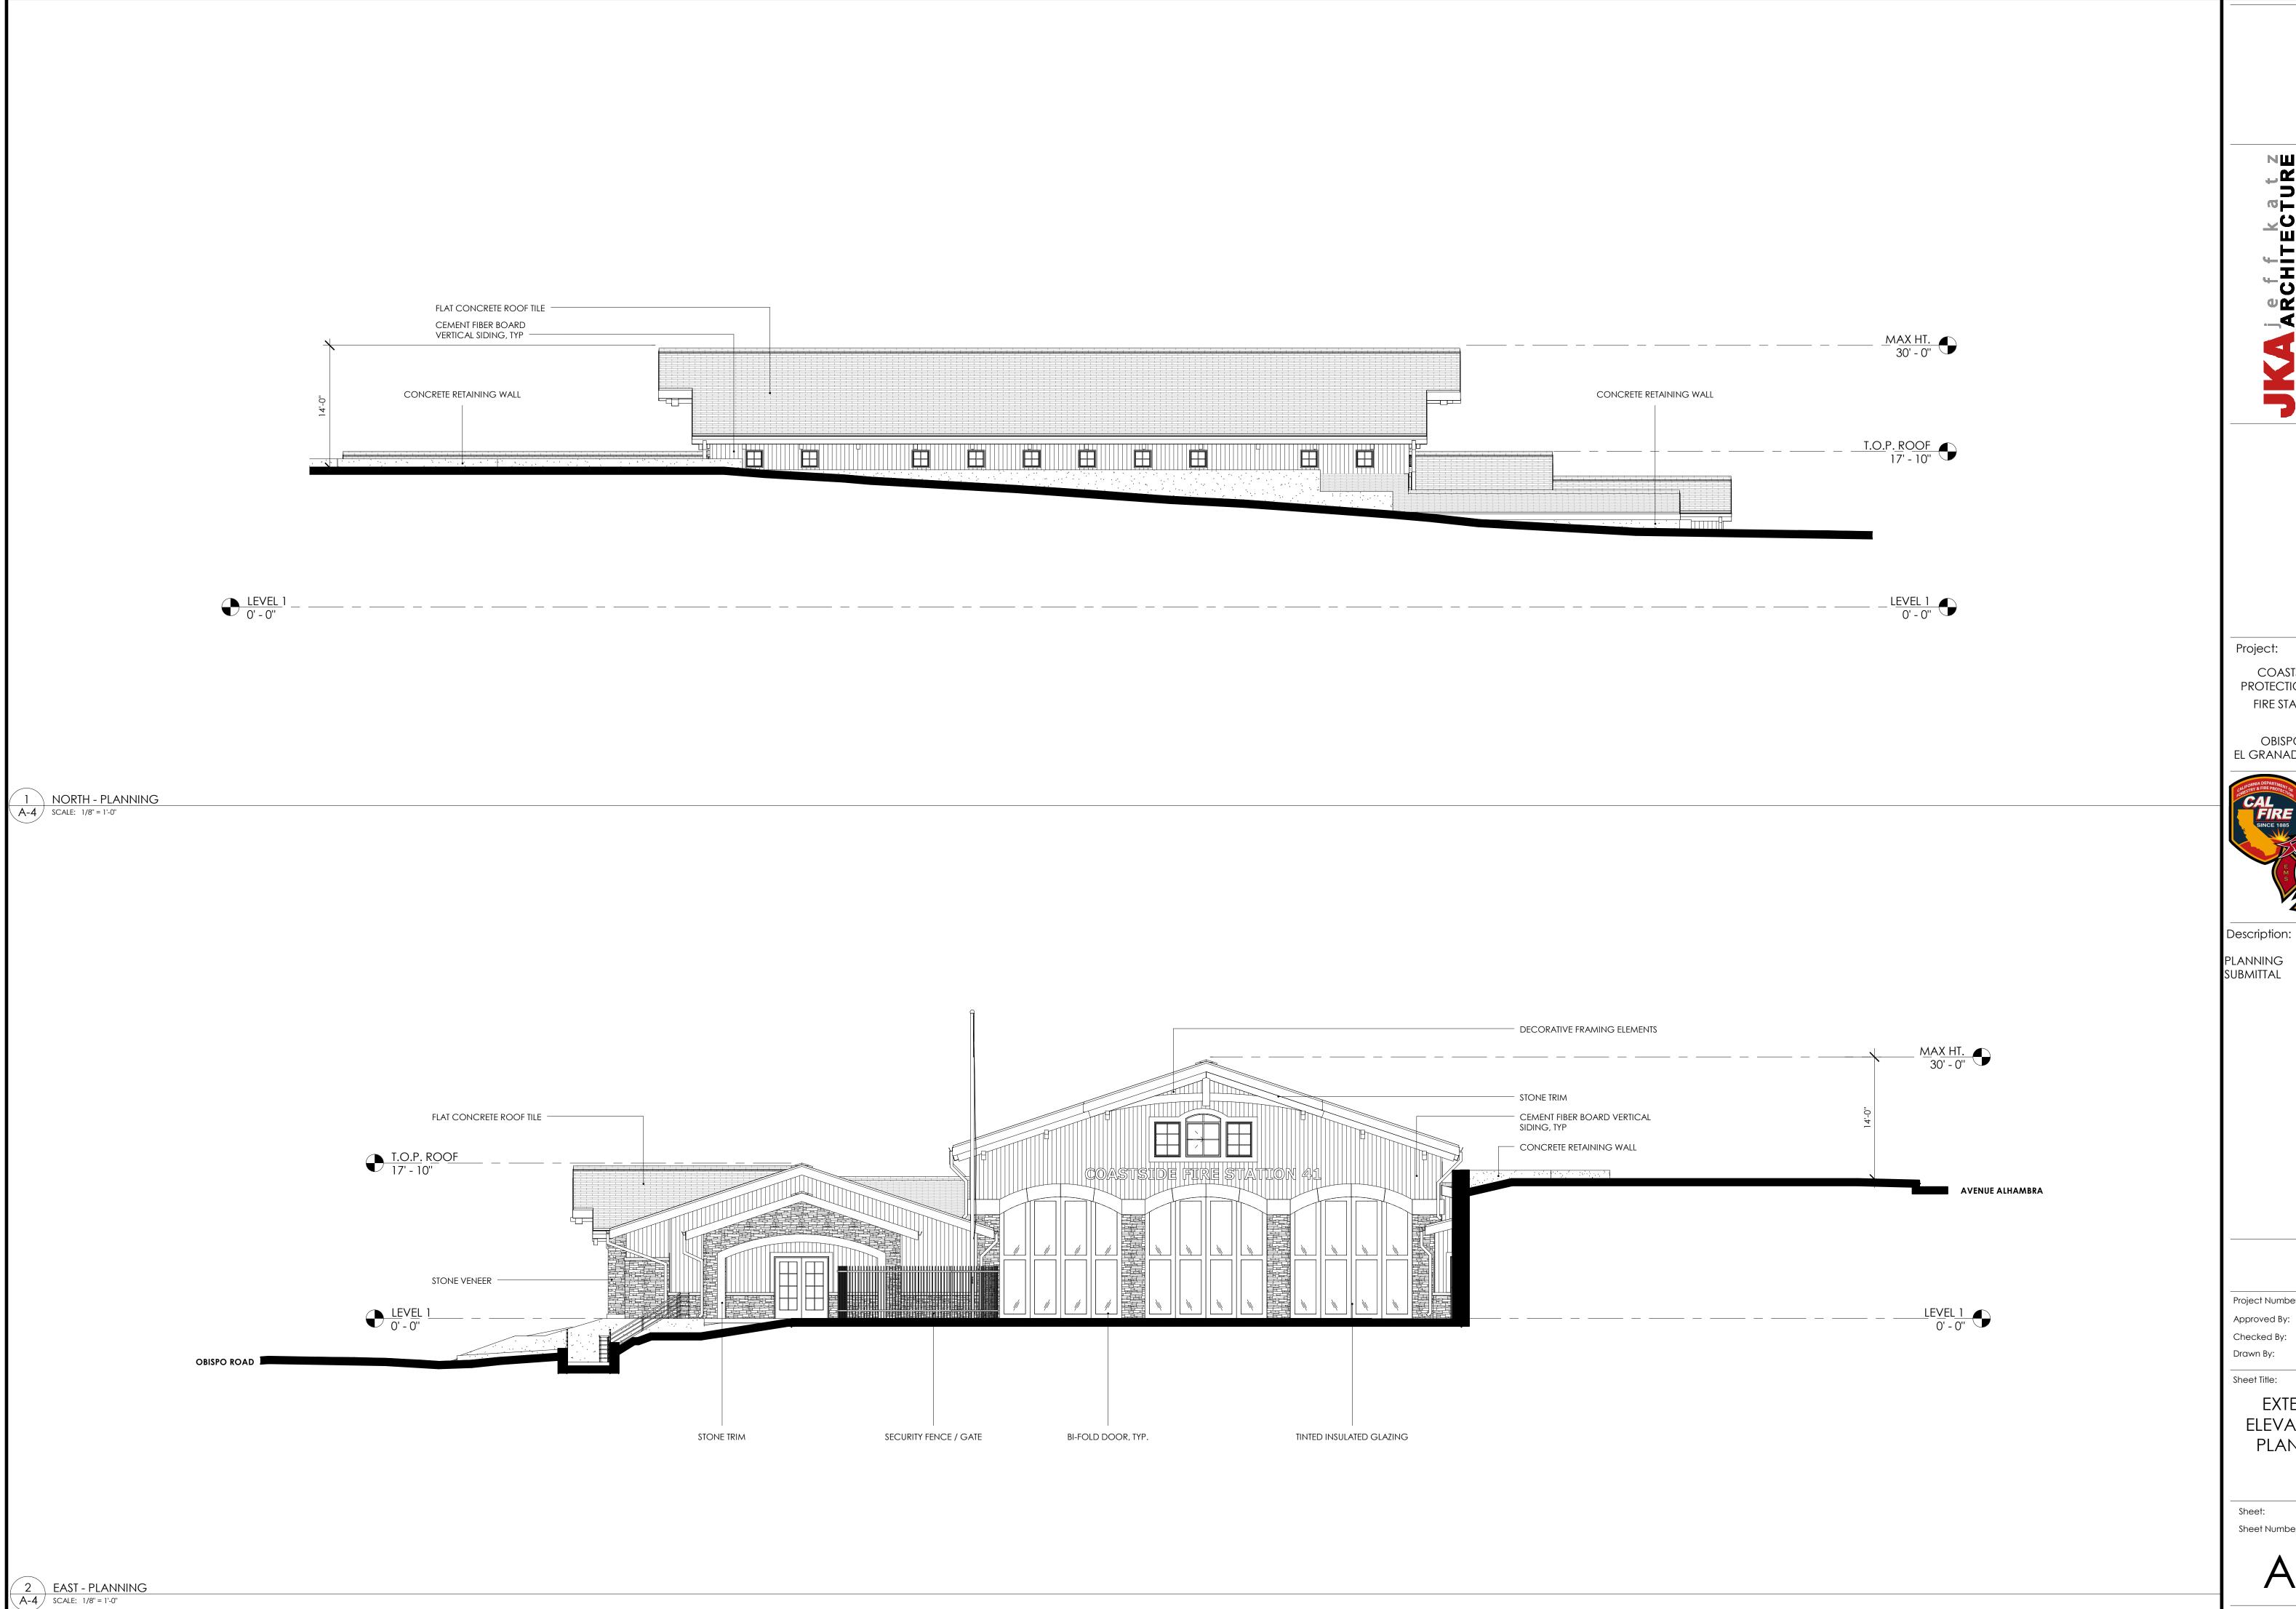
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Sheet Title:

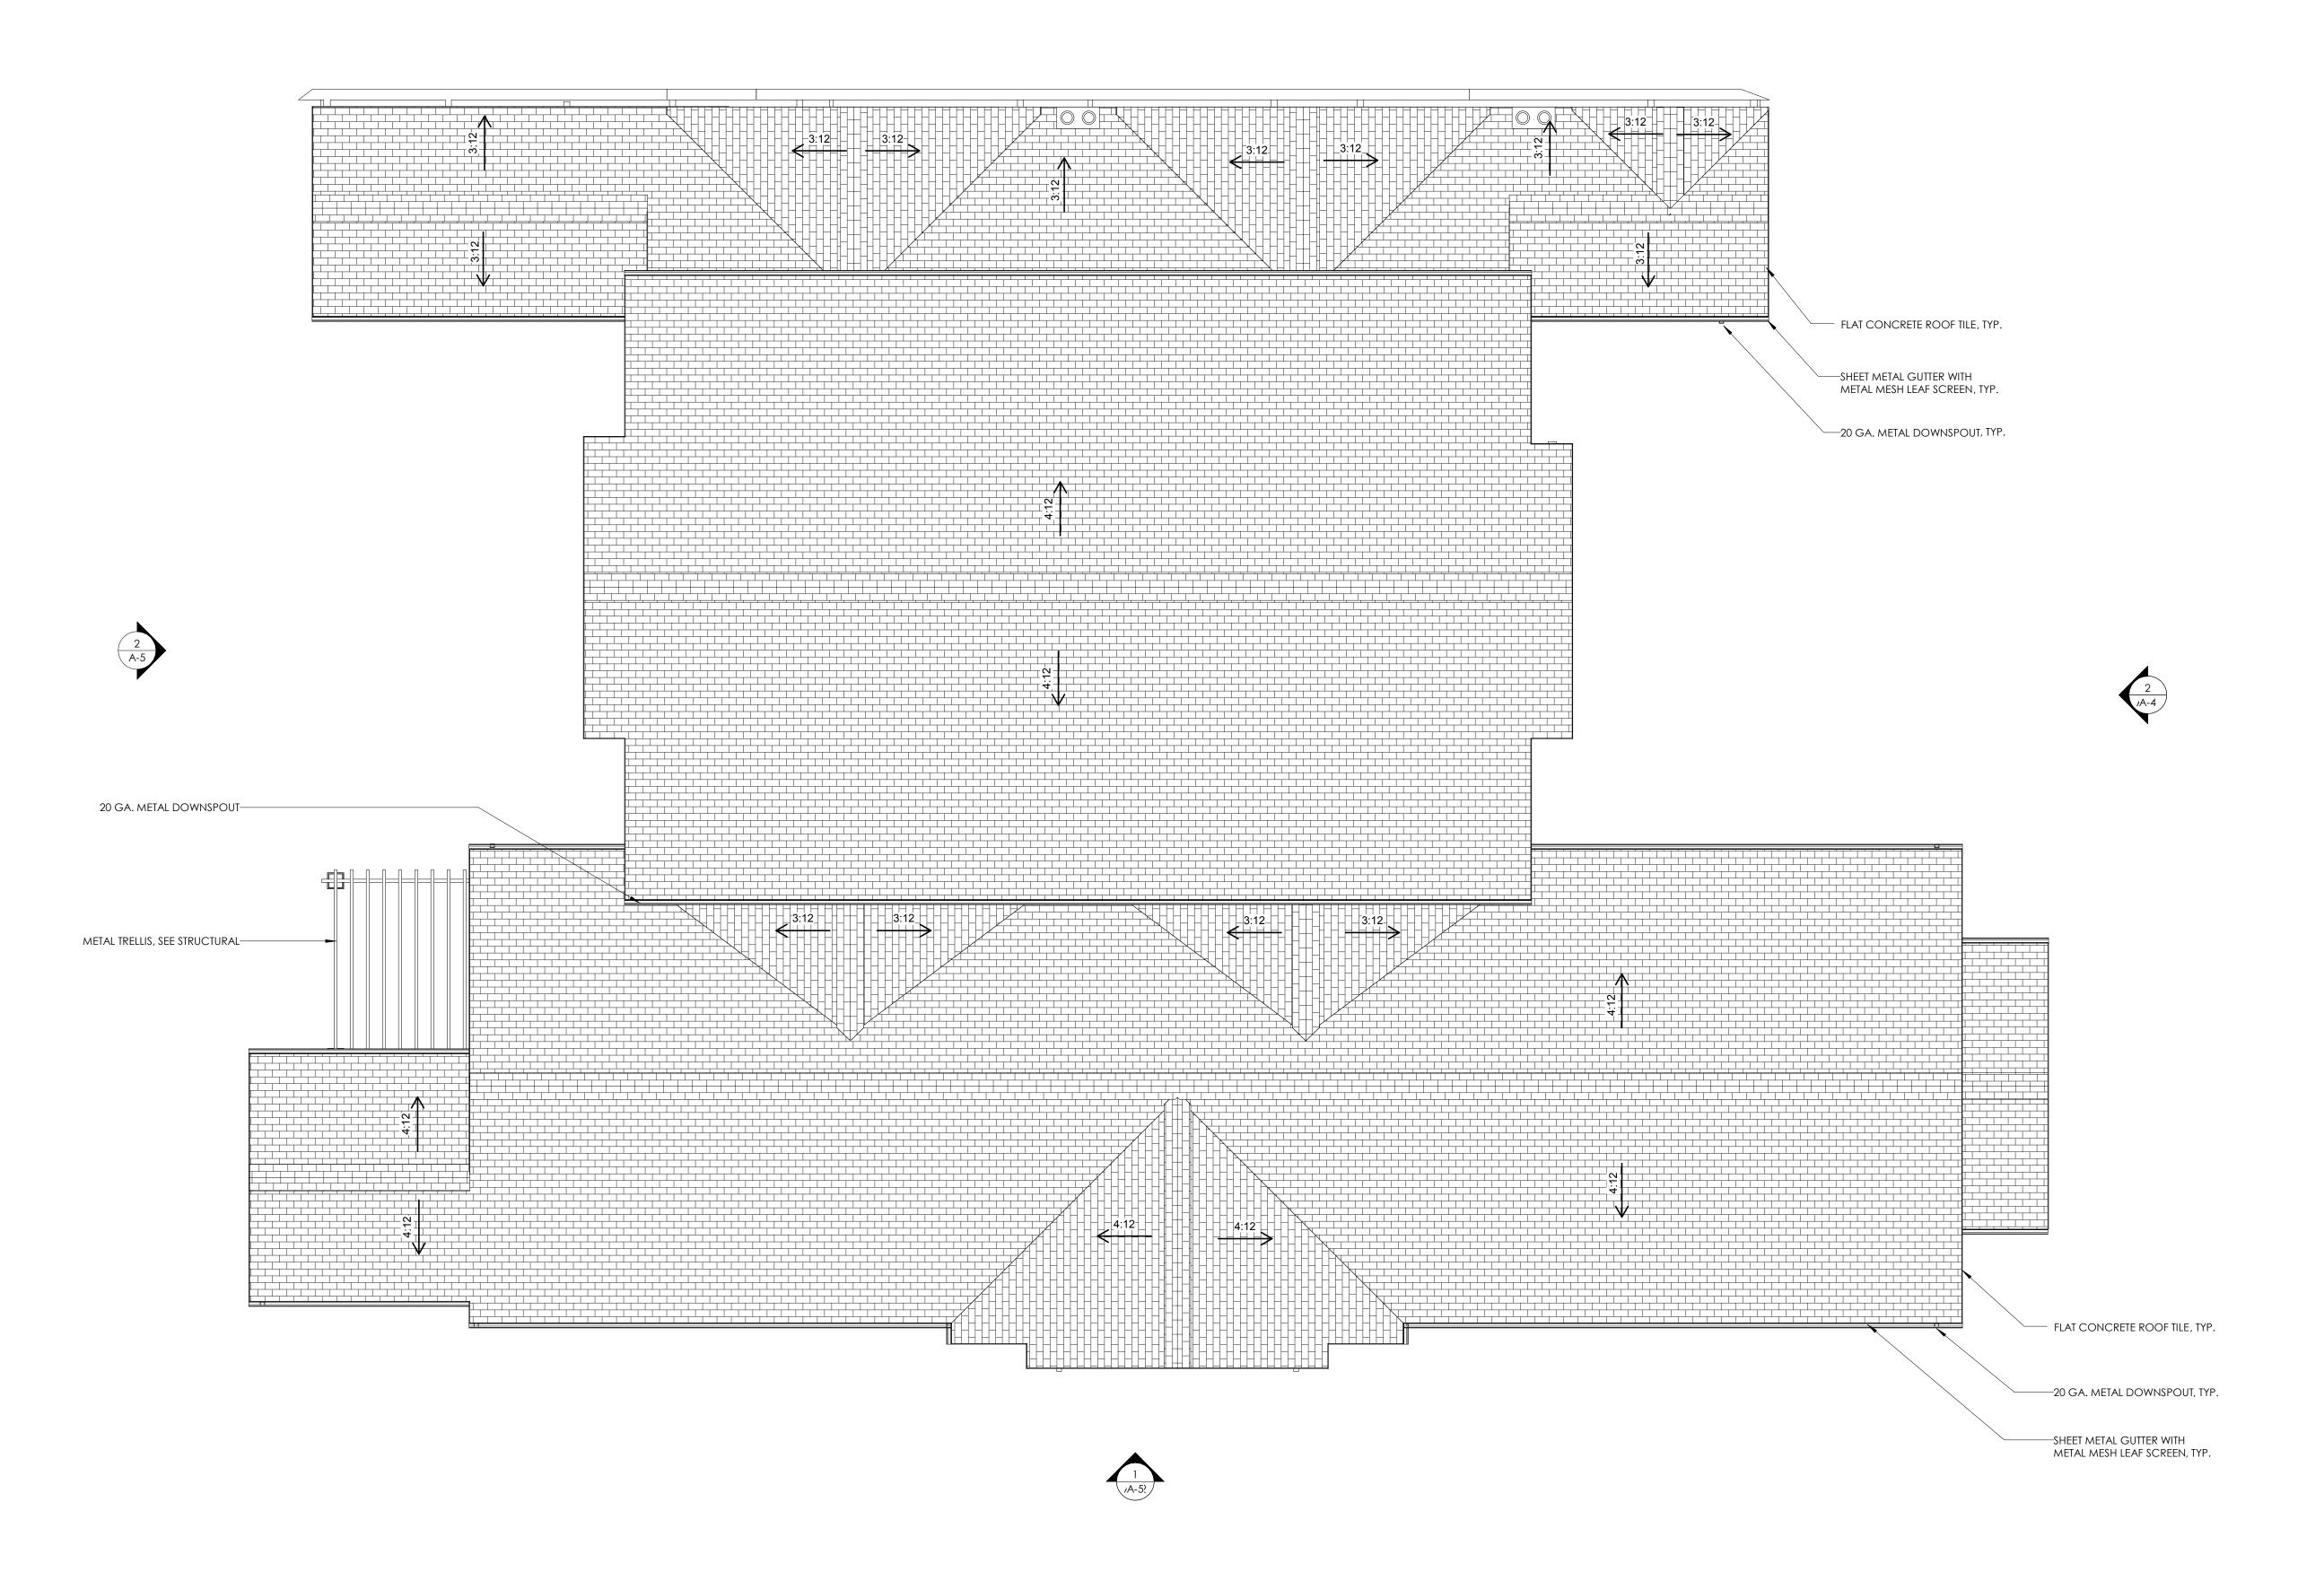ROOF PLAN -PLANNING

Sheet: 10 OF 16 Sheet Number:

A-3



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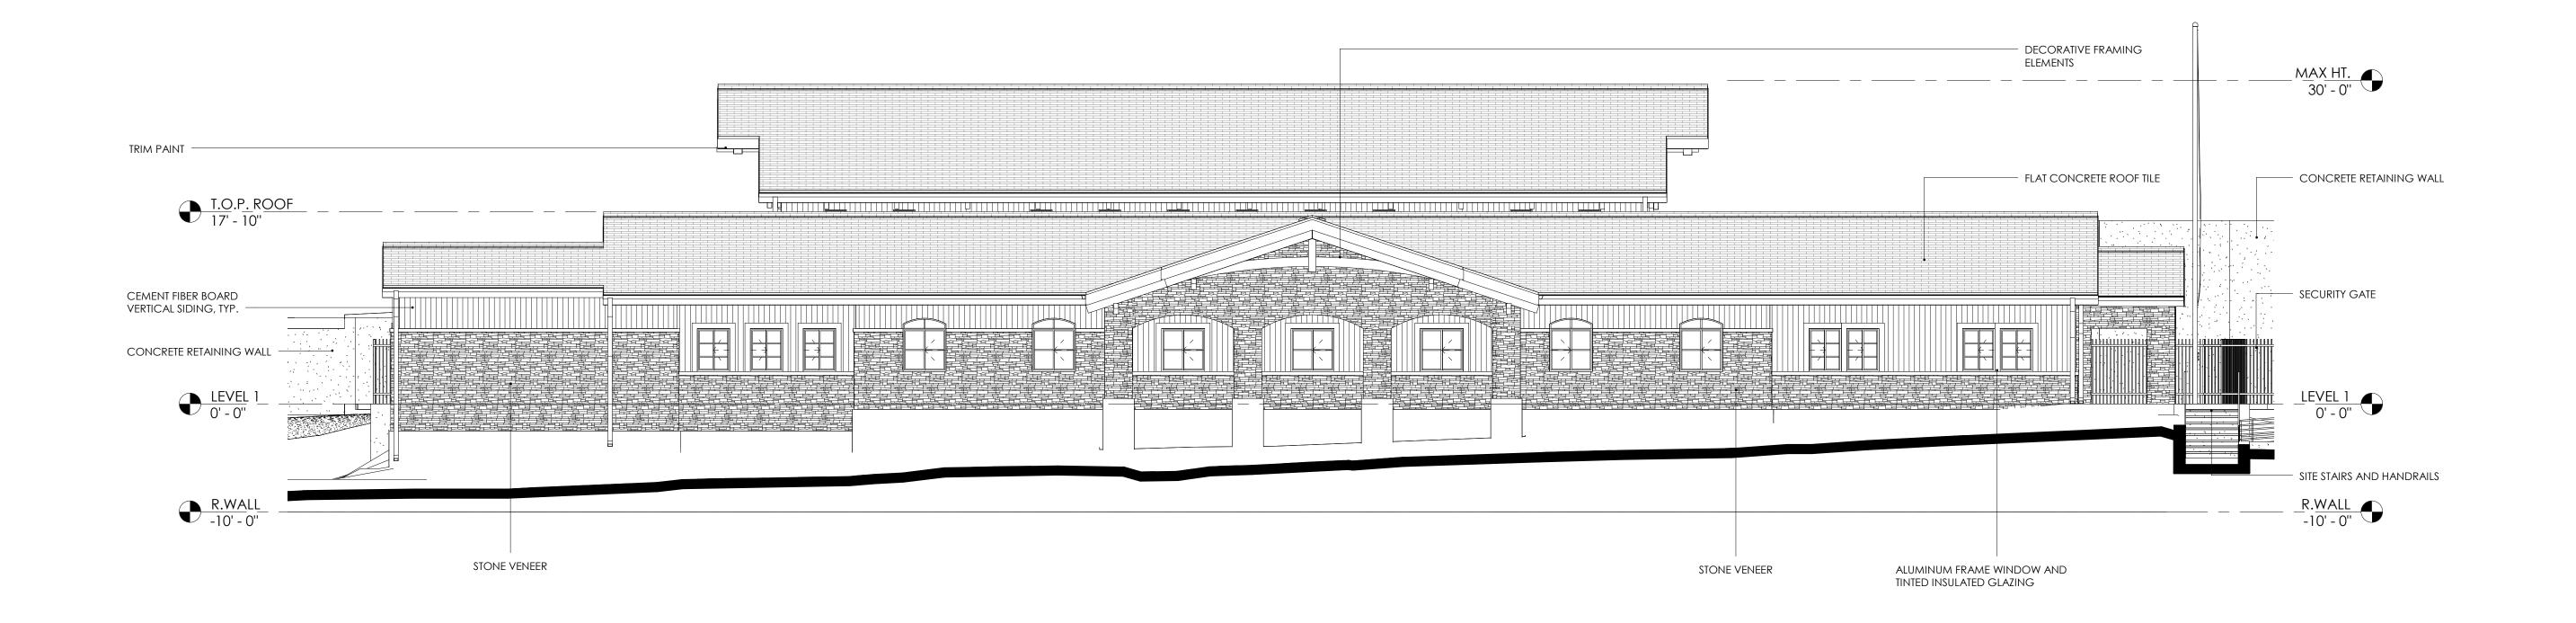
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Sheet Title: **EXTERIOR** 


ELEVATIONS -PLANNING

11 OF 16 Sheet Number:



1 SOUTH - PLANNING A-5 SCALE: 1/8" = 1'-0"

WEST - PLANNING
SCALE: 1/8" = 1'-0"

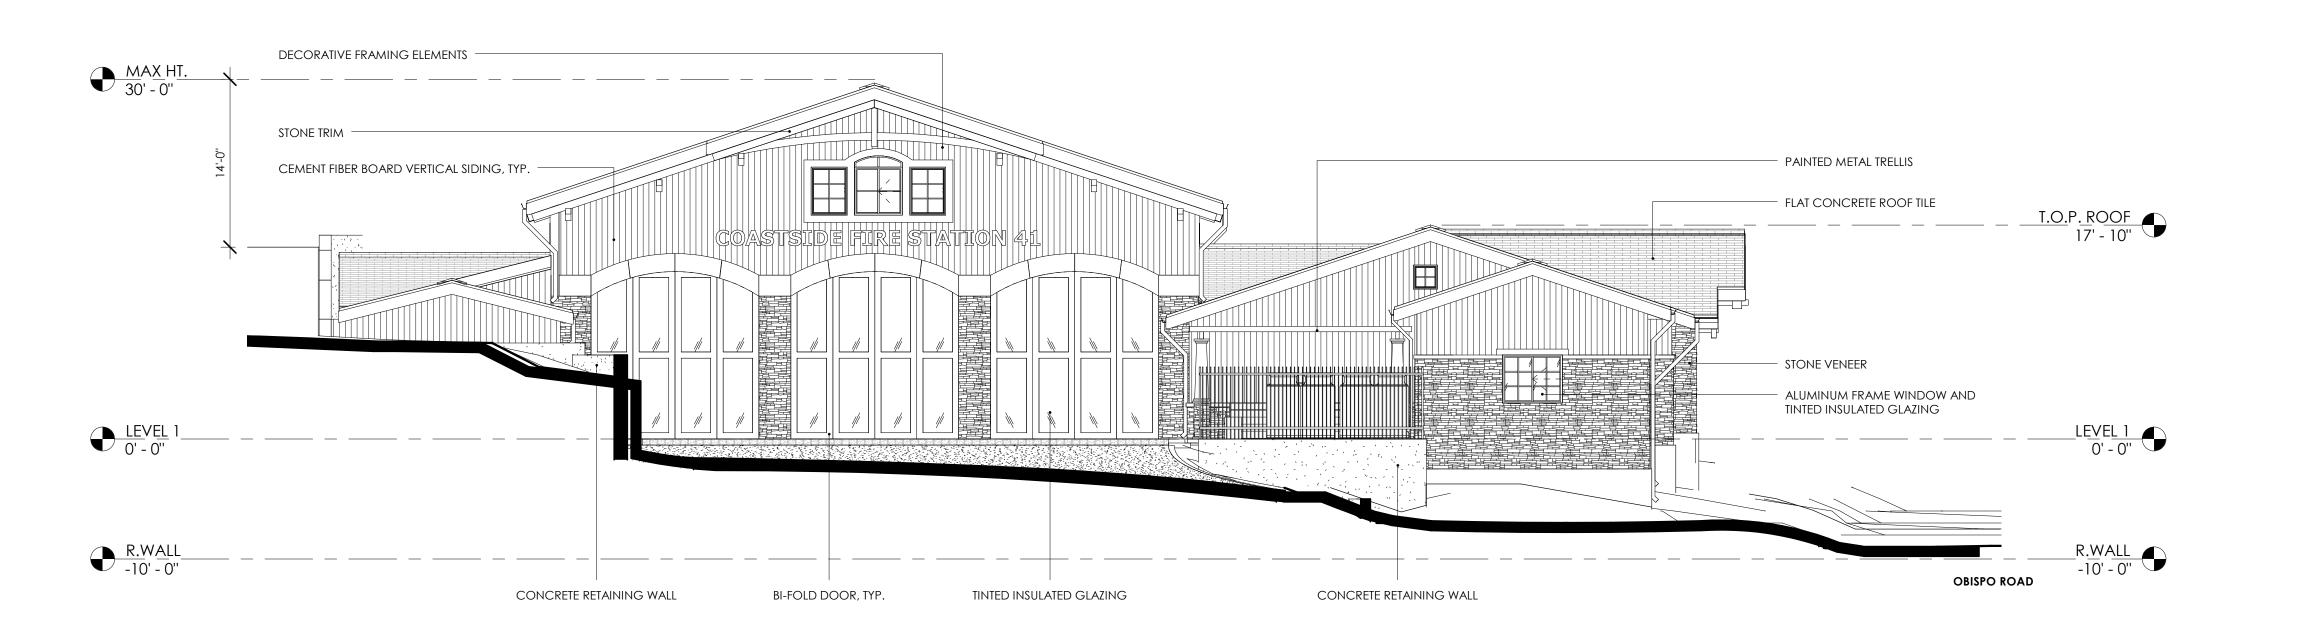

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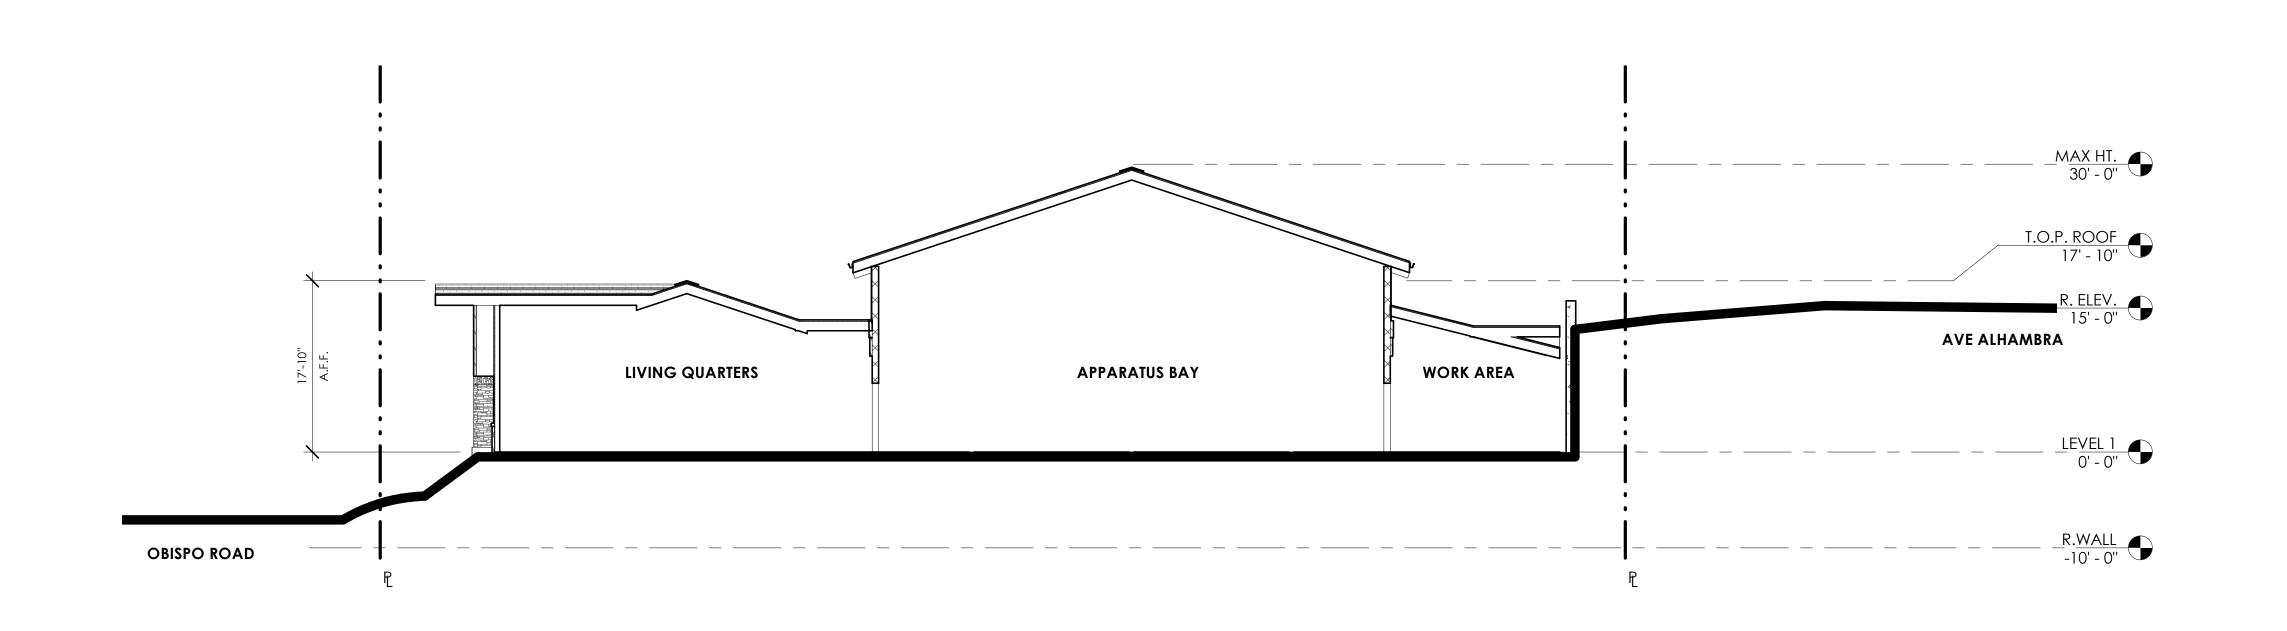
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Sheet Title:

EXTERIOR ELEVATIONS -PLANNING

Sheet: 12 OF 16 Sheet Number:

A-5



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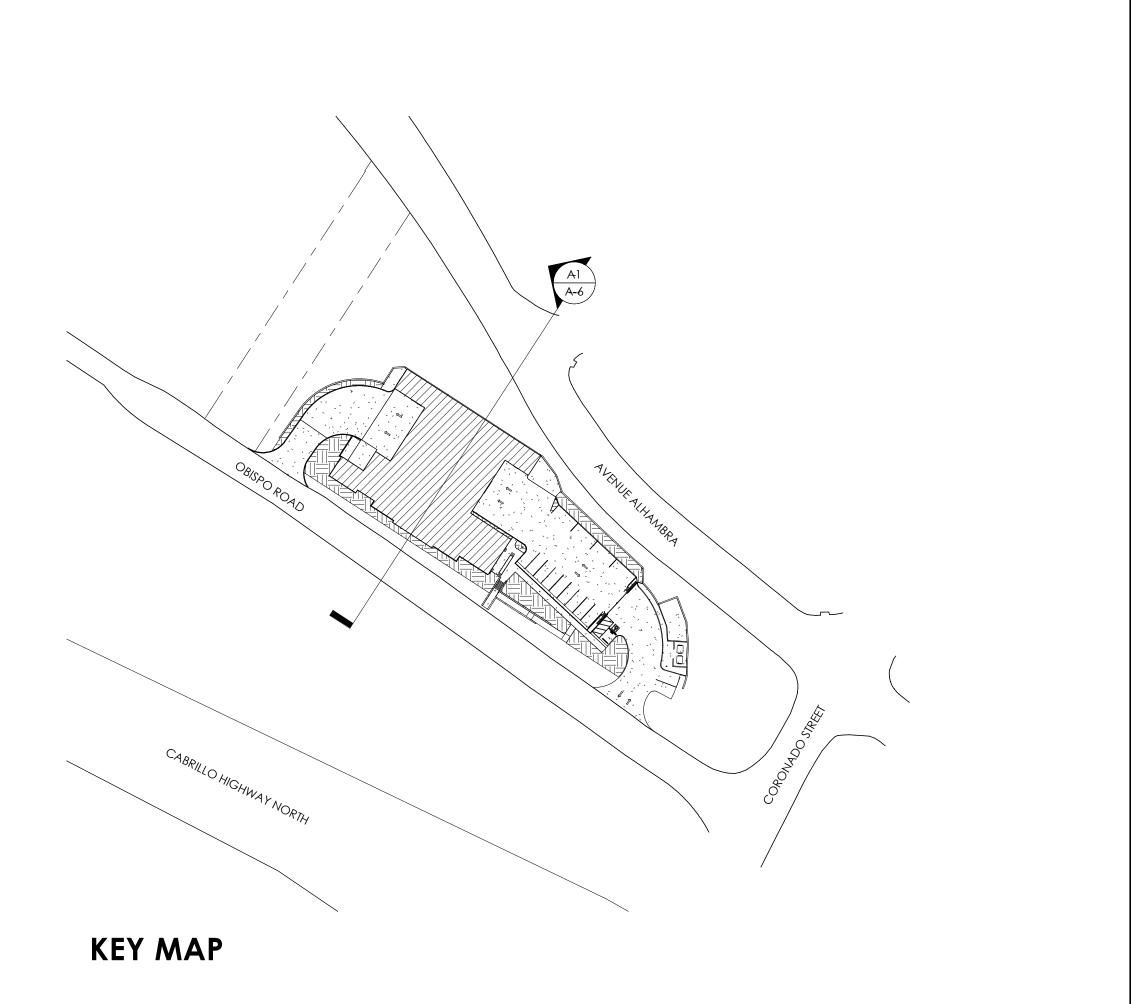
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Sheet Title:

SITE SECTION -PLANNING

Sheet Number:

13 OF 16



A1 SITE SECTION
A-6 SCALE: 1" = 10'-0"



VIEW 1 FROM OBISPO ROAD



VIEW 2 FROM OBISPO ROAD

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Sheet: 14
Sheet Number:

A-7



VIEW 1 FROM AVENUE ALHAMBRA



VIEW 2 FROM AVENUE ALHAMBRA

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Sheet: 15 Sheet Number:

8-A

